
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This file or an individual page shall not be considered a certified document.

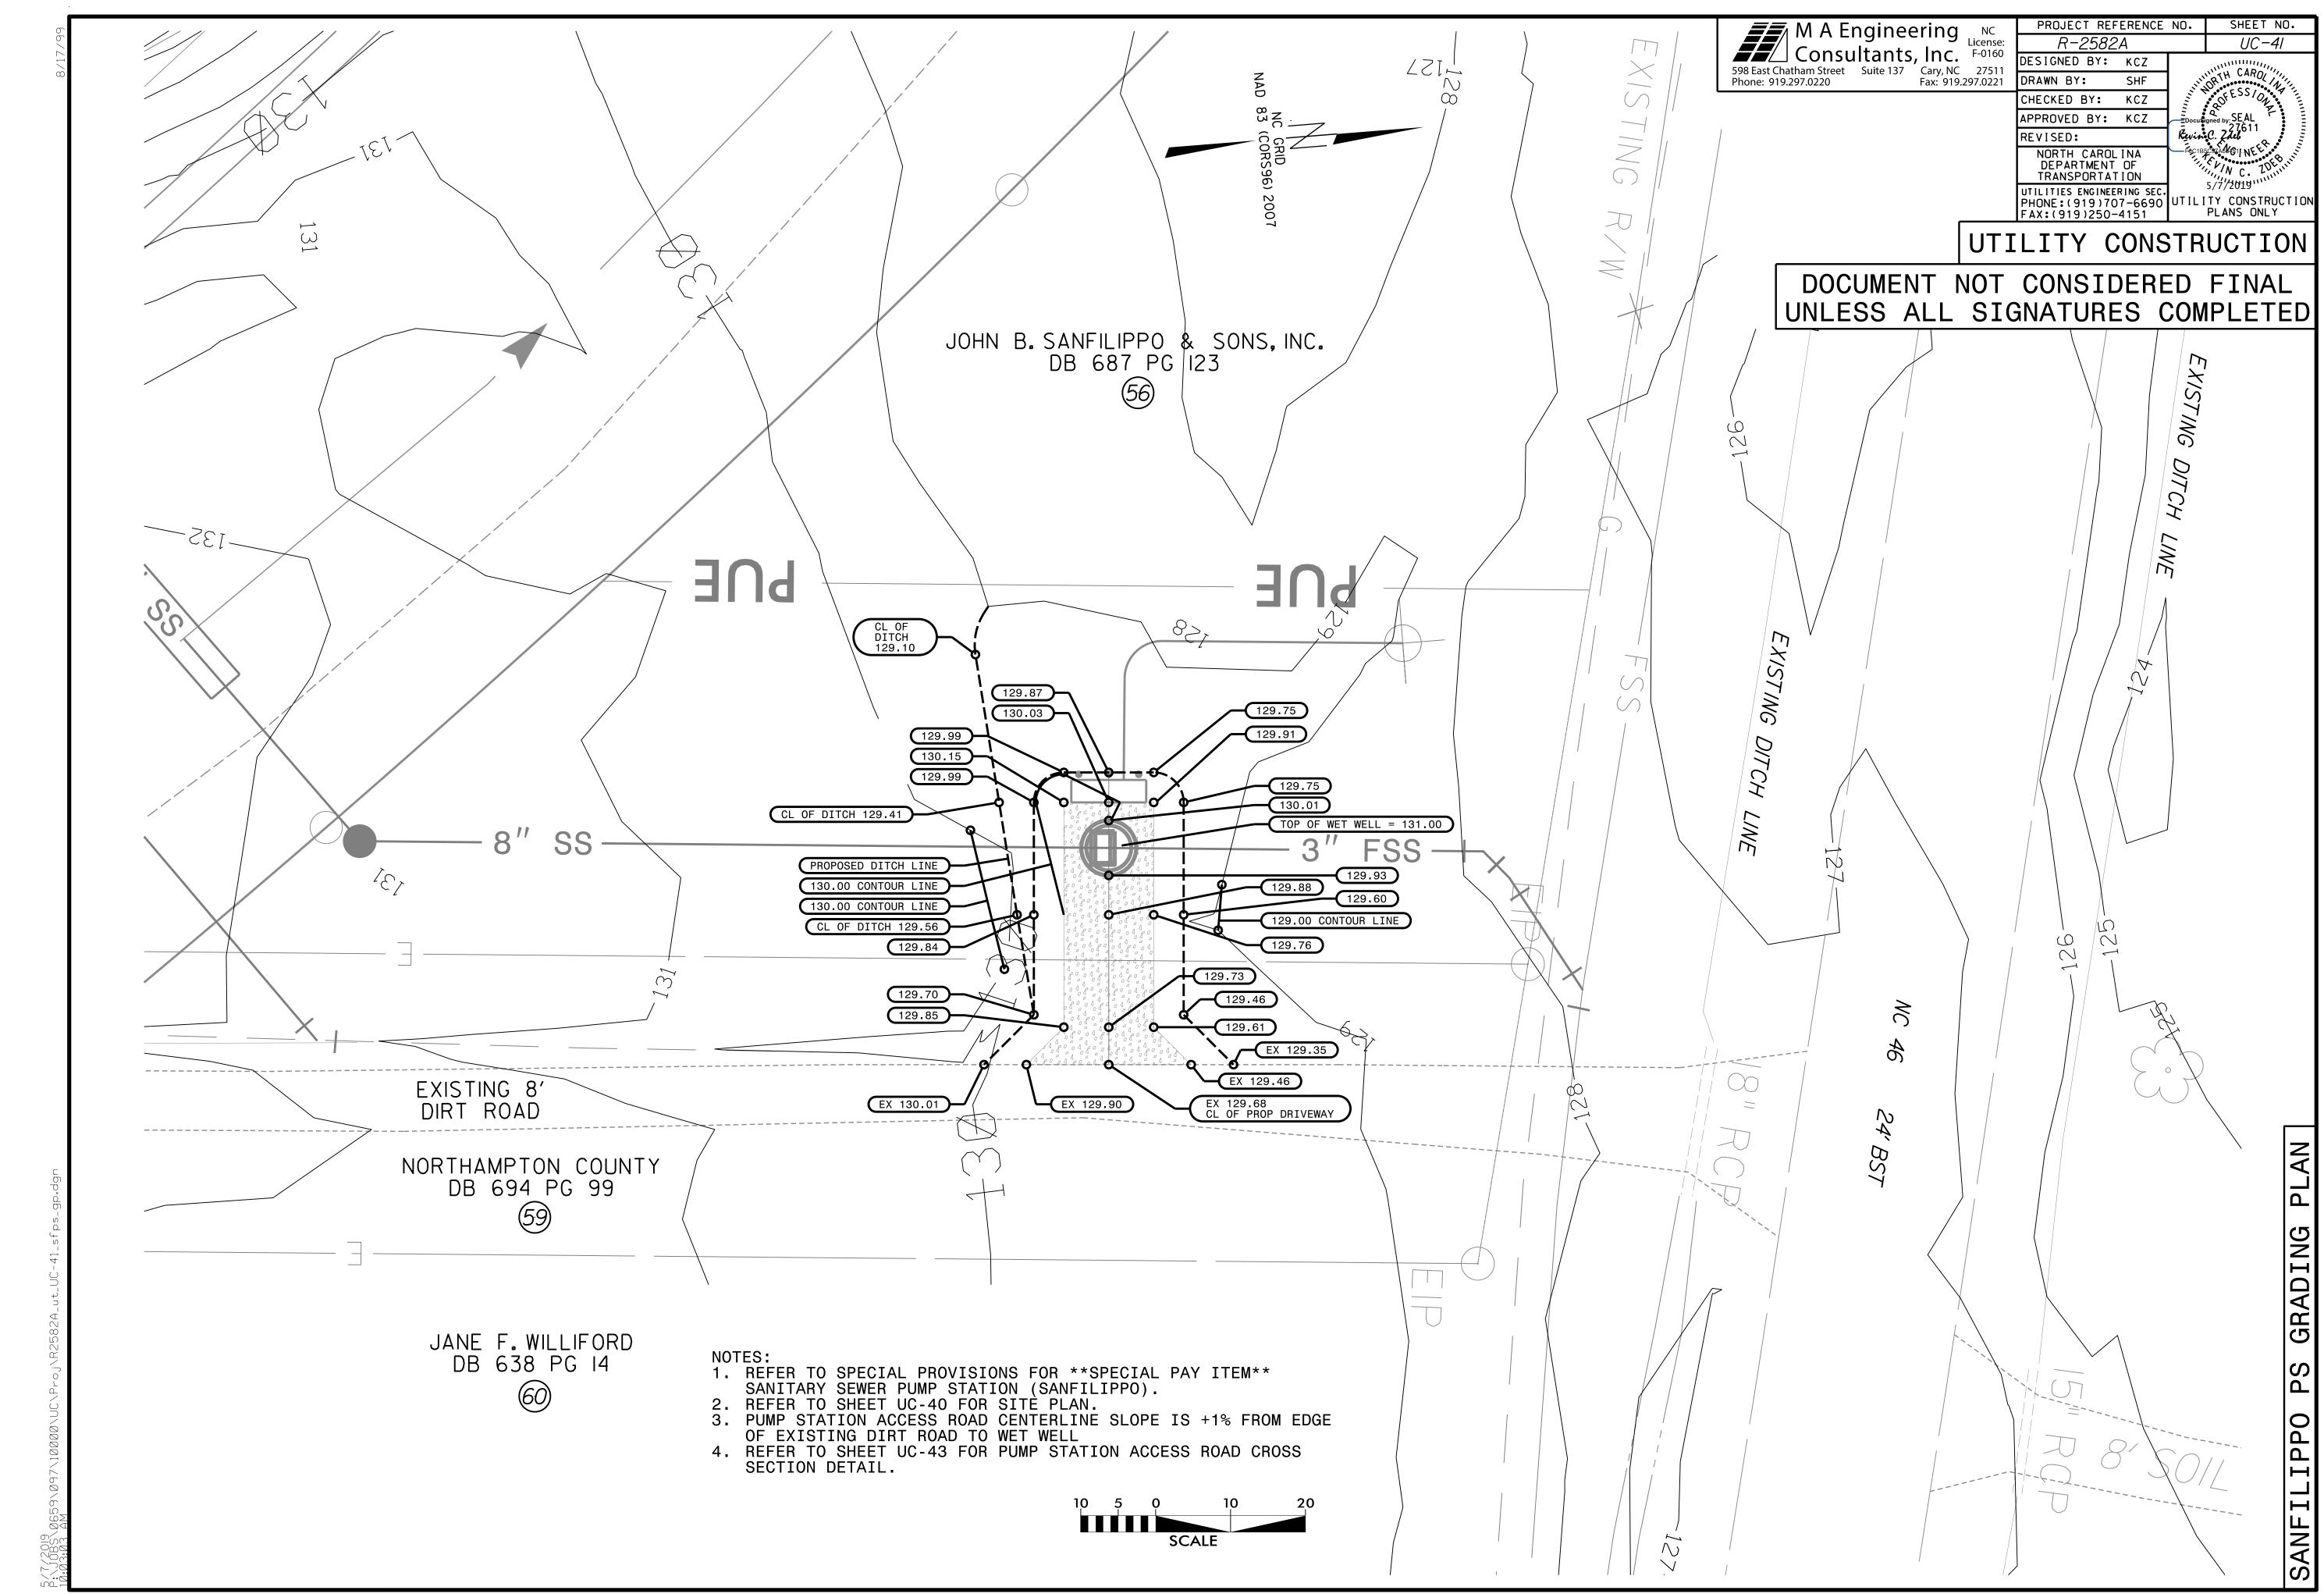



EXISTING SANFILIPPO PUMP STATION SHALL BE REMOVED AFTER NEW PUMP STATION HAS BEEN FULLY TESTED, ACCEPTED BY UTILITY OWNER, AND PLACED INTO SERVICE.

PUMP STATION SHALL MEET ALL STATE MINIMUM DESIGN REQUIREMENTS.

WET WELL SHALL BE EPOXY COATED (80 MILS).

PUMPS SHALL BE BARNES MODEL NO. XSGV3032L OR APPROVED EQUAL.

BREAK AWAY FITTING SHALL BE BARNES MODEL NO. BAFEZ-2x3 OR APPROVED EQUAL. 3" GATE VALVES SHALL BE PROVIDED WITH PIPE SUPPORT (NOT SHOWN).

TOP SLAB:

FORCE MAIN INVERT:

GRAVITY INVERT:

HIGH WATER ALARM:

GROUND:

LAG PUMP ON: 117.16 LEAD PUMP ON: 116.83 PUMPS OFF: 116.16 LOW WATER ALARM: 116.08 WET WELL BOTTOM: 115.33

WET WELL AND CONTROL ELEVATIONS

131.00

130.00

125.78

118.66

117.66

3" PVC SDR-21 FORCE MAIN OUTLET PIPING -(WITH FLANGE ADAPTER TO CONNECT TO TEE) 24"x48" ACCESS HATCH SEE DETAIL 3" GATE VALVE (TYP.) — VALVE ACCESS HOLE AND VALVE BOX COVER. CONCRETE FILLER HOLE TO MATCH VALVE BOX STANDARD SIZE. (TYP.)INFLUENT PIPE 8" -SDR - 35PORTABLE PUMP HOIST SLEEVE 3"X3" TEE (CAST IN PLACE). FLANGE SEE NOTE 1. SUBMERSIBLE PUMP (TYP.) -4" DIP VENT PIPE BREAK AWAY FITTING (TYP) W/ BIRD SCREEN 4" WET WELL VENT ALUMINUM ACCESS HATCH - VALVE BOX ACCESS HOLE (CAST IN PLACE) & FALL PROTECTION GRATING TOP SLAB SHALL BE 12" ABOVE MINIMUM 6" STONE SURROUNDING GRADE DRIVEWAY SCHEDULE 40 GUIDE RAILS WITH STAINLESS STEEL -INTERMEDIATE SUPPORTS AS NEEDED LIFTING CHAIN — 3" GATE VALVE FOR PUMP (TYP. FOR 2) ─ 3" PVC SDR-21 FORCE MAIN STAINLESS STEEL LIFTING CHAIN FOR TRASH BASKET — 3" BALL CHECK VALVE PUMP POWER CABLE -— 3" FLANGED D.I.P. (TYP. INSIDE WET WELL) REMOVABLE - MERCURY HIGH/LOW TRASH BASKET

FLOAT SWITCH

CONCRETE FILLET


MINIMUM 6"

OF #57 STONE

- BREAK AWAY FITTING

CONTINUOUS @ 1H:1V

6' PRE—CAST CONCRETE WET WELL EXTENDED BASE AND RISERS

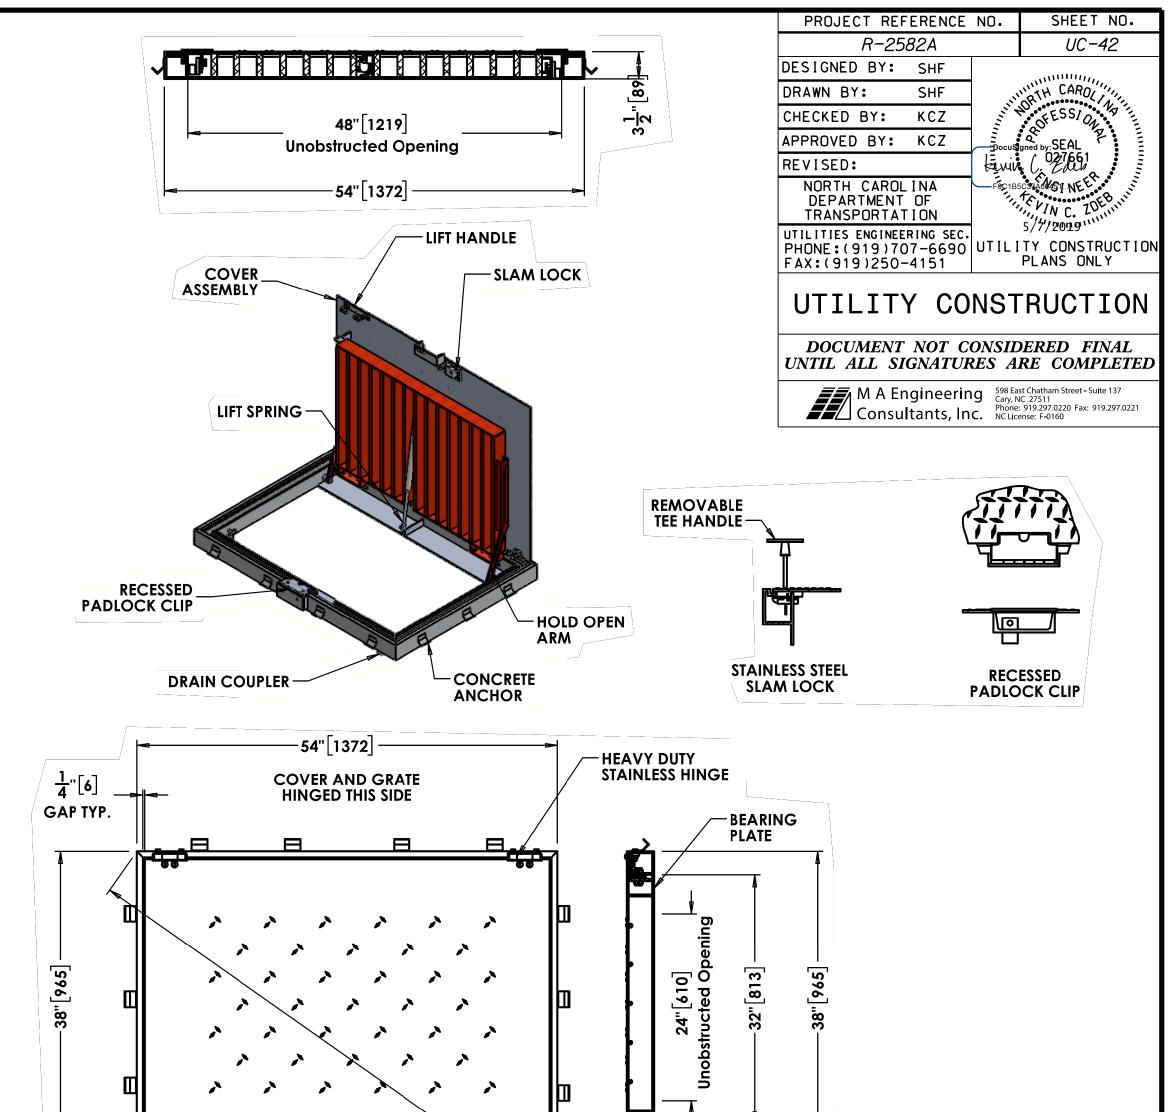

 $-66\frac{1}{32}$ "[1677]

BEARING

- 1. MATERIAL SHALL BE 6061-T6 ALUMINUM FOR BARS, ANGLES AND EXTRUSIONS, 1/4" DIAMOND PLATE SHALL BE 5086 ALUMINUM.
- UNIT DESIGNED HEAVY DUTY, FOR 16,000 LBS + 30% IMPACT H-20 WHEEL LOADS, OVER A 10" X 20" CONTACT AREA. FRAMES AND BEARING PLATE MUST BE CAST INTO AND SUPPORTED BY CONCRETE DESIGNED FOR H-20 WHEEL LOADS.
- UNIT NOT SUITABLE FOR WHEEL LINE PLACEMENT.
- UNIT SUPPLIED WITH A HEAVY DUTY PNEU-SPRING, FOR EASE OF OPERATION WHEN OPENING GRATE. GRATE SHALL BE COUNTERBALANCÉD, SO ONE PERSON CAN EASILY OPEN THE SAFETY GRATE.
- FRAME SHALL BE OF EXTRUDED ALUMINUM. A DOVETAIL GROOVE SHALL BE EXTRUDED
- FRAME SHALL BE OF EXTRUDED ALUMINUM. A DOVETAIL GROOVE SHALL BE EXTRUDED INTO THE SEAT OF THE FRAME FOR A 1/8" SILICONE GASKET.

 EACH HATCH SHALL BE EQUIPPED WITH A STAINLESS STEEL HOLD OPEN ARM. DOOR SHALL LOCK OPEN IN THE 90 DEGREE POSITION. HOLD OPEN ARM SHALL BE FASTENED TO THE FRAME WITH A 1/2" GRADE 316 STAINLESS STEEL BOLT.

 HINGES SHALL BE OF HEAVY DUTY DESIGN. MATERIAL SHALL BE GRADE 316 STAINLESS STEEL. EACH HINGE SHALL HAVE A GRADE 316 STAINLESS STEEL, 3/8" DIAMETER HINGE PIN. HINGE SHALL BE FASTENED TO THE CHANNEL FRAME AND DIAMOND PLATE WITH GRADE 316 STAINLESS STEEL BOLTS AND NY-LOCK NUT.

 ALUMINUM SHALL BE SUPPLIED WITH MILL FINISH. EXTERIOR OF FRAME WHICH COMES IN CONTACT WITH CONCRETE SHALL HAVE ONE COAT BLACK PRIMER.

 EACH HATCH SHALL BE SUPPLIED WITH A 316 STAINLESS STEEL SLAM LOCK, WITH THE KEY WAY PROTECTED BY A THREADED ALUMINUM PLUG. THE PLUG SHALL BE FLUSH WITH THE TOP OF THE 1/4" DIAMOND PLATE. THE SLAM LOCK SHALL BE FASTENED WITH
- THE TOP OF THE 1/4" DIAMOND PLATE. THE SLAM LOCK SHALL BE FASTENED WITH GRADE 316 STAINLESS STEEL BOLTS AND WASHERS.
- 10. EACH HATCH SHALL BE SUPPLIED WITH A RECESSED PADLOCK CLIP (PADLOCK BY OTHERS).
- 11. EACH HÁTCH SHALL BE EQUIPPED WITH A STAINLESS STEEL LIFT HANDLE. LIFT HANDLES SHALL BE FLUSH WITH TOP OF 1/4" DIAMOND PLATE.
- 12. EACH HATCH IS SUPPLIED WITH A 1-1/2" THREADED DRAIN COUPLER ON THE UNDERSIDE OF CHANNEL FRAME, FOR PIPE CONNECTION. (SPECIAL LOCATION).

SANFILIPPO ACCESS HATCH NOT TO SCALE

(SEE DETAIL ON UC-43)

INFLUENT PIPE —

SUBMERSIBLE PUMP —

SANFILIPPO PUMP STATION PLAN AND PROFILE

SCALE: 1"=2

8" SDR-35

RUBBER BOOT TYPICAL

ALL WALL OPENINGS

NOTES:


1. HOIST SOCKET SHALL BE PROVIDED WITH STAINLESS STEEL TYPE-316 CONSTRUCTION.

2. HOIST SOCKET SHALL BE PROVIDED WITH POLYMER LINING FOR

SMOOTHER ROTATION.
3. HOIST SOKET SHALL BE CAST INTO TOP SLAB.


EMBEDDED PORTABLE HOIST SOCKET


NOT TO SCALE

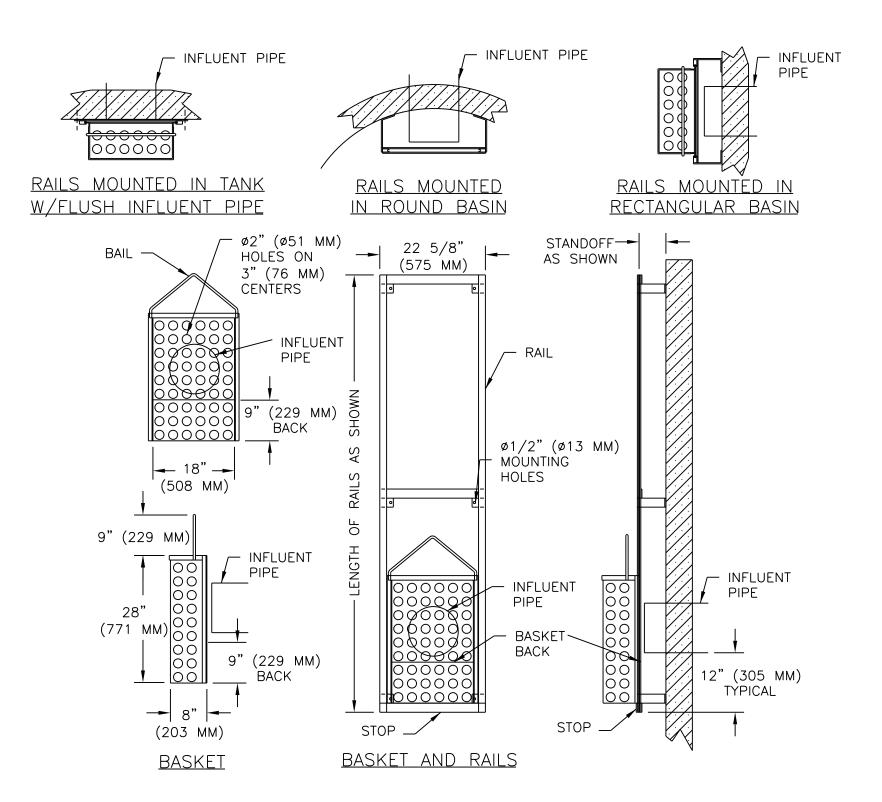

SERIES B1A TRASH BASKET DETAIL

NOT TO SCALE

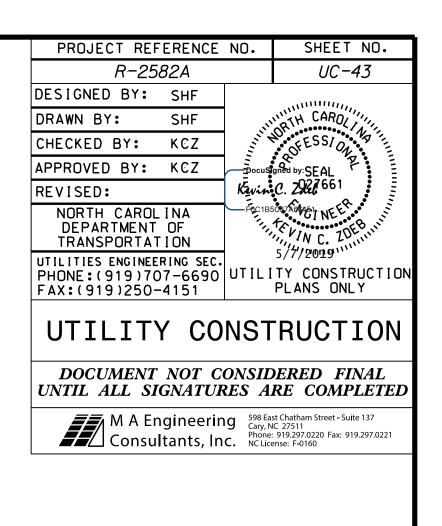

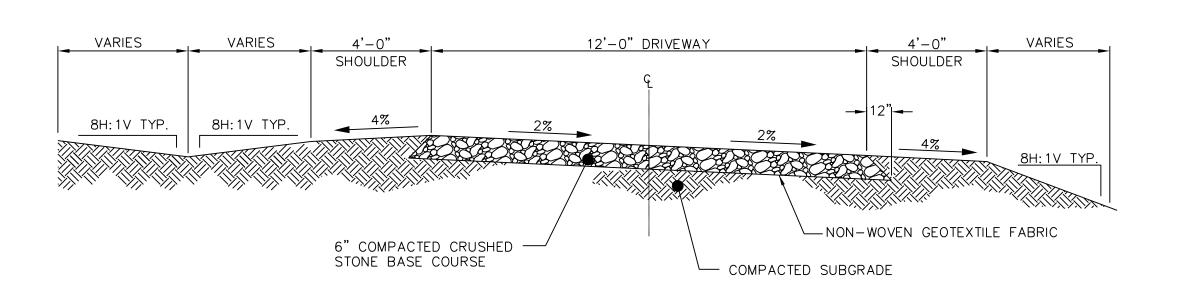

SANFILIPPO PUMP STATION ACCESS ROAD DETAIL

NOT TO SCALE

NOTES: 1. SLOPES SHALL NOT BE STEEPER THAN 3H:1V BEYOND SHOULDER POINT. EXOTHERMIC WELD OR MECHANICAL
CONNECTION; REFER TO APPROPRIATE
DETAIL CONNECTION
EQUIPMENT CONNECTION;

COORDINATE WITH SUPPLIER PRIOR TO ROUGH-IN

GFI RECEPTACLE;

WEATHER PROOF COVER

C100 - REFER TO CONDUIT & CABLE SCHEDULE.

ELECTRICAL DISCONNECT;

NUMBER INDICATES TYPE; REFER

TO DISCONNECT SCHEDULE

SINGLE POLE SWITCH; COORDINATE LOCATION

WITH DOOR SWING & MILLWORK; MOUNTING

HEIGHT PER NC STATE BLDG CODE VOL 1-C

UNSWITCHED CIRCUIT

SWITCHED CIRCUIT

	DRAWING SCHEDU			3		
		ISSUE	DOT REVIEW			
DRAWING NUMBER	DRAWING TITLE	DATE	05/06/2019			
UC-44	ELECTRICAL COVER SHEET SANFILIPPO		•			
UC-45	ELECTRICAL POWER RISER SANFILIPPO		•			
UC-46	CONDUIT AND CABLE SCHEDULE SANFILIPPO		•			
UC-47	DETAILS SANFILIPPO		•			

M A Engineering NC License: Consultants, Inc. F-0160

598 East Chatham Street Suite 137 Cary, NC 27511
Phone: 919.297.0220 Fax: 919.297.0221

PROJECT REFERENCE NO. SHEET NO. R-2582A UC-44 ESIGNED BY: REF DRAWN BY: REF CHECKED BY: REF APPROVED BY: REF Kesel Finn REVISED: NORTH CAROLINA DEPARTMENT OF TRANSPORTATION UTILITIES ENGINEERING SEC. PHONE: (919)707-6690 UTILITY CONSTRUCTION FAX:(919)250-4151

UTILITY CONSTRUCTION

DOCUMENT NOT CONSIDERED FINAL UNLESS ALL SIGNATURES COMPLETED

ENERGY CODE INFORMATION

Electrical System and Equipment

Method of Compliance: Prescriptive

Lighting Schedule

Lamp type required in fixture — See Fixture Schedule Number of lamps in fixture — See Fixture Schedule Ballast type used in fixture — See Fixture Schedule

Number of ballasts in fixture — See Fixture Schedule Total wattage per fixture — See Fixture Schedule Total interior wattage specified vs. allowed — N/A

Total exterior wattage specified vs. allowed — 78.6 lumens/watt specified vs. 45 lumens/watt allowed

Equipment schedules with motors (not used for mechanical systems)

Motor horsepower — N/A Number of phases — N/A

Minimum efficiency - N/A

Motor type - N/Å # of poles - N/A

sianor Statomont

Designer Statement:
To the best of my knowledge and belief, the design of this building complies with the electrical system and equipment requirements of North Carolina International Energy code


Signed: _

Name: REESE E. FINN

Title: Engineer

	LIGHT FIXTURE SCHEDULE											
ID	DESCRIPTION	LAMP/ QTY	BALLAST/ QTY	VOLTS	WATTS	NOTES						
A	LITHONIA EIS 2 54T5HO	T5H0 54W 2	GEB 1	120	108	ENCLOSED & GASKETED FLOURESCENT STRIP, WET LABEL, SURFACE MOUNTED. CONTRACTOR TO FURNISH & INSTALL.						

MISC. DWG. SYMBOLS

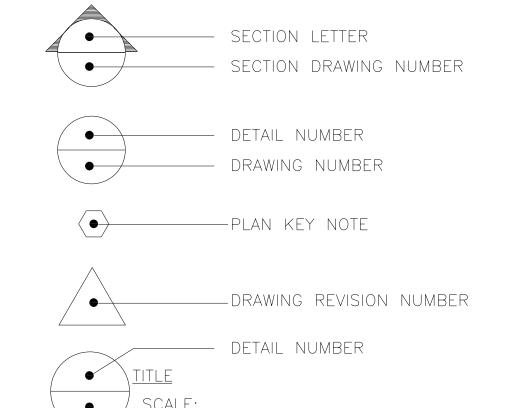

DRAWING NUMBER


NOTE TO REVIEWER


NOTE TO REVIEWER

THIS APPLICATION IS TO PROVIDE UTILITY POWER AND CONTROL WIRING FOR A RELOCATED PUMPING STATION.

UTILITY CONSTRUCTION

DOCUMENT NOT CONSIDERED FINAL UNLESS ALL SIGNATURES COMPLETED

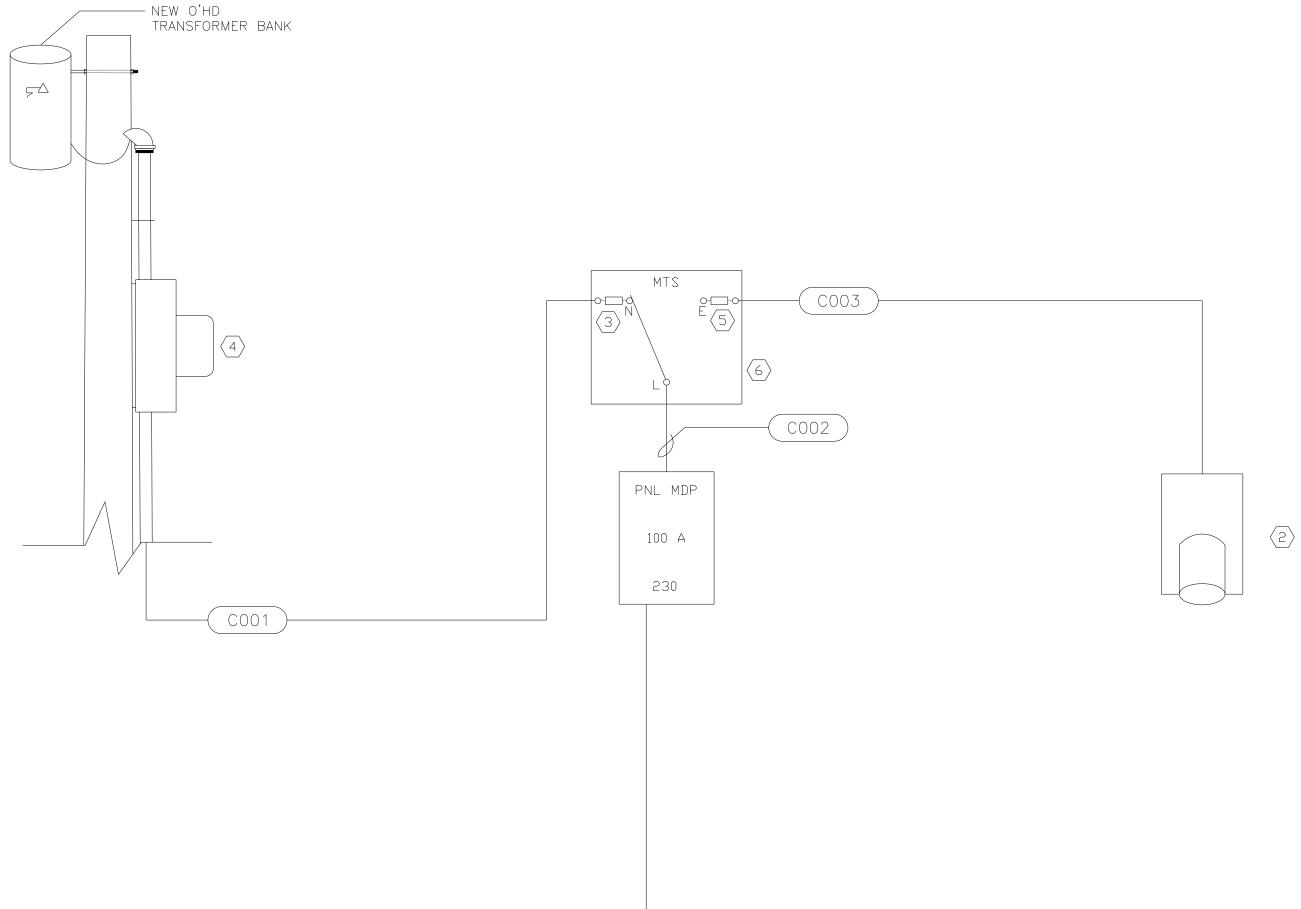

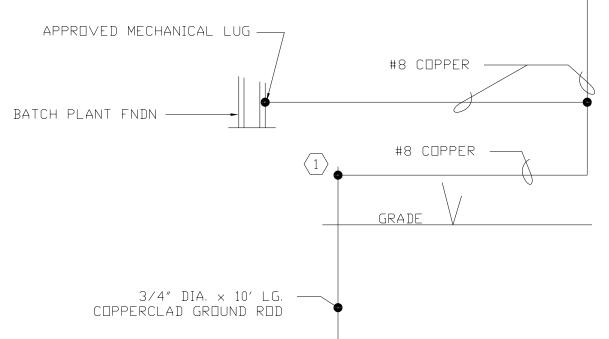



GENERAL NOTE:

THE CONDUIT ROUTING IS DIAGRAMMATIC. REFER TO CONDUIT & CABLE SCHEDULE FOR SIZE & CABLE CONTENT. THE EXACT ROUTING AND COORDINATION WITH SITE CONDITIONS IS THE CONTRACTORS RESPONSIBILITY.

<u>Keyed Notes:</u>

- APPROVED

 MECHANICAL
 GROUNDING LUG.
- KILLARK VERSAMATE 60A 2W 3P RECEPTACLE.

 MODEL VR632E4. COORDINATE WITH OWNER'S EQUIPMENT.
- (3) RK5 100A FUSE
- UTILITY METER. COORDINATE

 4 LOCATION AND TYPE WITH
 UTILITY.
- (5) RK5 60A FUSE
- SQUARE D DT223RB

 (6) NEMA 3R DOUBLE THROW
 FUSED SWITCH.

Α	OLTAGE: 230 MPS: 100 MC: 12,158						PANEL MDP							MAIN BREAKER: M.L.O. PHASE: 3 WIRE: 4 MOUNTING: SURFACE				
							PHASE	LOADS										
KT	DESCRIPTION	С	W	Р	СВ		Α	В	VA	СВ	P	W	С	DESCRIPTION	CKT			
1 P	PUMP - 1	3/4	10	2	30	2040	2220		180	20	1	12	1/2	RECEPTACLE	2			
3				2	30	2040		2040							4			
5 P	PUMP - 2	3/4	10	2	30	2040	2160		120	20	1	12	1/2	CANOPY LIGHT	6			
7				2	30	2040		2340	300	15	1	14	1/2	PLC CONTROL	8			
9							0								10			
11								0							12			
13							0								14			
15								0							16			
17							0								18			
-					VA	/PHASE:	4380	4380		!		!	N	IECLOAD: 9780				
					Т	OTAL VA:		8760						AMPS: 25				
					TOT	AL AMPS:		22										
OTES	S:			N	ECLOAD	/PHASE:	4890	4890										
. PRO	S: DVIDE BOLT-ON BREAKER JARE D NQOD	ıs		N	T TOT	OTAL VA: AL AMPS:		8760 22										

/17/99

M A Engineering NC License: Consultants, Inc. F-0160

598 East Chatham Street Suite 137 Cary, NC 27511 Phone: 919.297.0220 Fax: 919.297.0221

PROJECT REFERENCE	NO.	SHEET NO.
R-2582A		UC-46
DESIGNED BY: REF		
DRAWN BY: REF		TH CARD
CHECKED BY: REF		MILLESS 10 THAT
APPROVED BY: REF	Docusi	gned by EAL
REVISED:	Res	Final /
NORTH CAROLINA DEPARTMENT OF TRANSPORTATION	E (C (20	SEE F
UTILITIES ENGINEERING SEC. PHONE: (919)707-6690 FAX: (919)250-4151	5/6/20 U⊺ILI	TY CONSTRUCTION PLANS ONLY

UTILITY CONSTRUCTION

DOCUMENT NOT CONSIDERED FINAL UNLESS ALL SIGNATURES COMPLETED

		CONDUIT AND CA	ABLE SCHEDULE	
CONDUIT I.D.	CONDUIT SIZE	CABLE/ WIRE	FROM	ТО
C001	1-1/4"	3 #3 THHN COPPER	METER BASE	MTS
C002	1-1/4"	3 #3 THHN COPPER	MTS	MDP
C003	1-1/4"	3 #3 THHN COPPER	MTS	GEN RECPT



GENERAL NOTES:

- ALL CONDUIT IS RIGID ALUMINUM

 1 UNLESS OTHERWISE NOTED ON THE
 PLANS
- CONTRACTOR IS RESPONSIBLE FOR ACTUAL QUANTITIES BASED ON TAKE OFF & FIELD CONDITIONS.

UTILITY CONSTRUCTION


DOCUMENT NOT CONSIDERED FINAL UNLESS ALL SIGNATURES COMPLETED


<u>Keyed Notes:</u>

- 60×60×12 NEMA 3R CONTROL


 (1) CABINET, PROVIDE BACK PANEL AND LOCKING HANDLE.
- MOUNT ATS, MDP, FLOW METER CONTROL UNIT, AND MISC. 2 CONTROL UNITS, SIZE IS NOMINAL, CONFIRM SPACE REQUIREMENTS WITH EQUIPMENT SUPPLIERS, ADJUST BOX SIZE IF REQUIRED.
- GFI RECEPTACLE

 WITH IN-USE COVER.
- SP SWITCH WITH WP COVER, CONTROLS CANOPY LIGHT.
- 2P DOUBLE THROW NEMA 3R MANUAL TRANSFER SWITCH, FUSED. SQUARE DDT223RB.
- WARMA FLASHING RED LED WARNING LIGHT, COORDINATE WITH CONTRLS VENDOR.
- KILLARK VERSAMATE 60A 2W 3P RECEPTACLE, MODEL VR632E4.
 COORDINATE WITH OWNER'S EQUIPMENT.

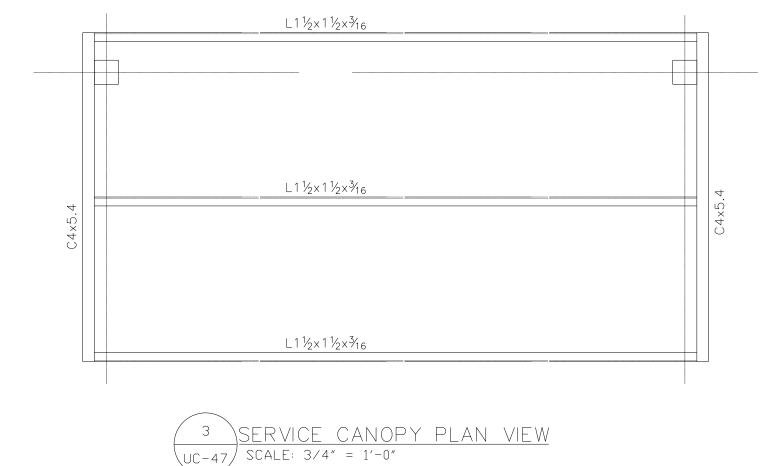

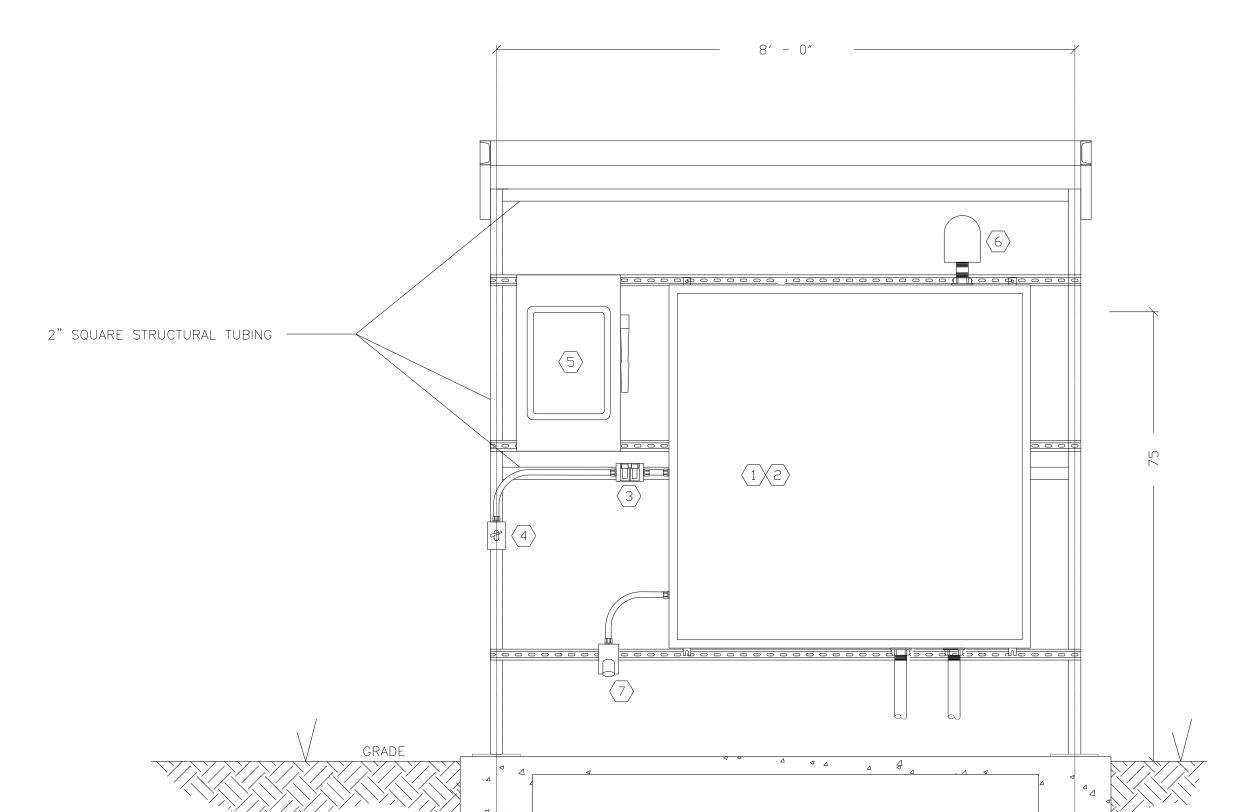

SERVICE CANOPY FRONT ELEVATION

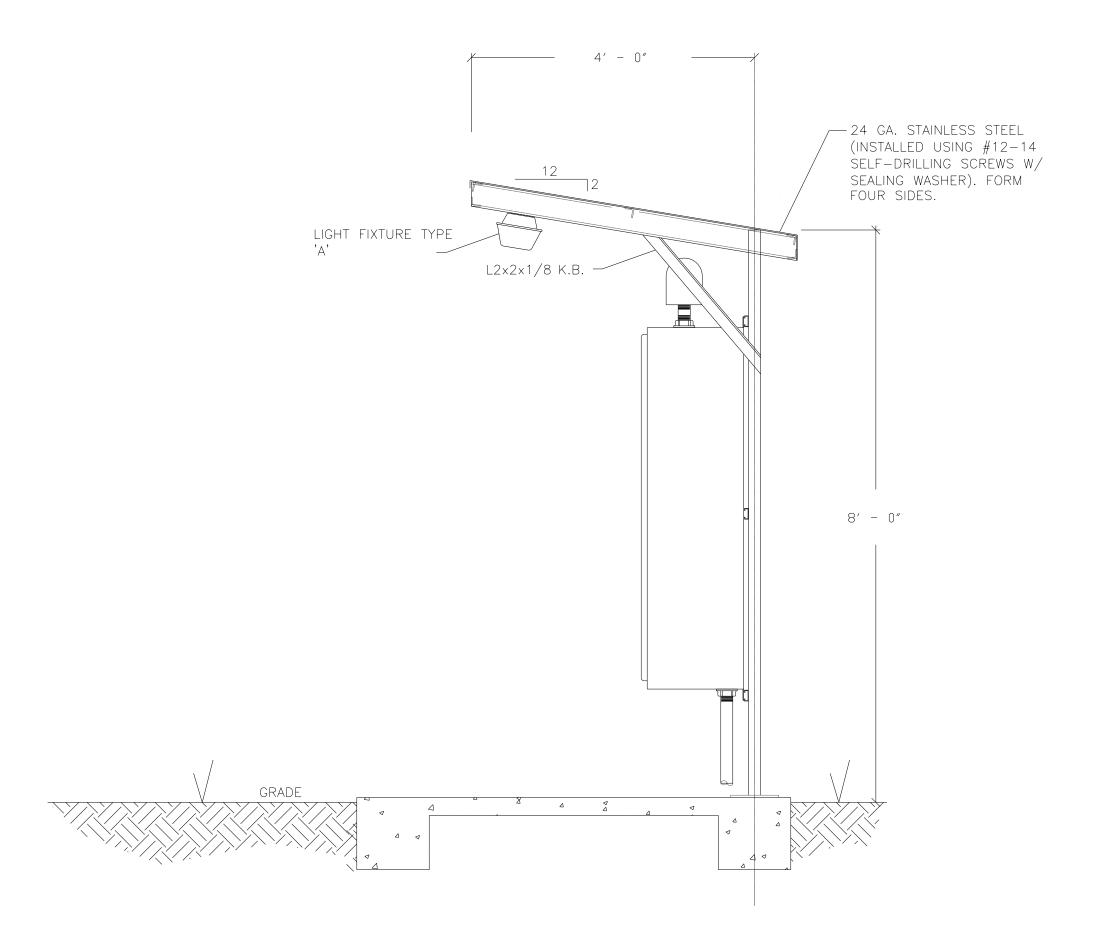

PROJECT: R-25824

STATE OF NORTH CAROLINA DIVISION OF HIGHWAYS T.I.P. NO.

R-2582A

OLD HIGHWAY RD.

UC-48


SHEET NO.

DOCUMENT NOT CONSIDERED FINAL UNTIL ALL SIGNATURES ARE COMPLETED

UTILITY CONSTRUCTION PLANS PS-1 PUMP STATION

LOCATION: INTERSECTION OF US-158/US-301 AND COLEMAN STREET IN GARYSBURG

TYPE OF WORK: SANITARY PUMP STATION CONSTRUCTION

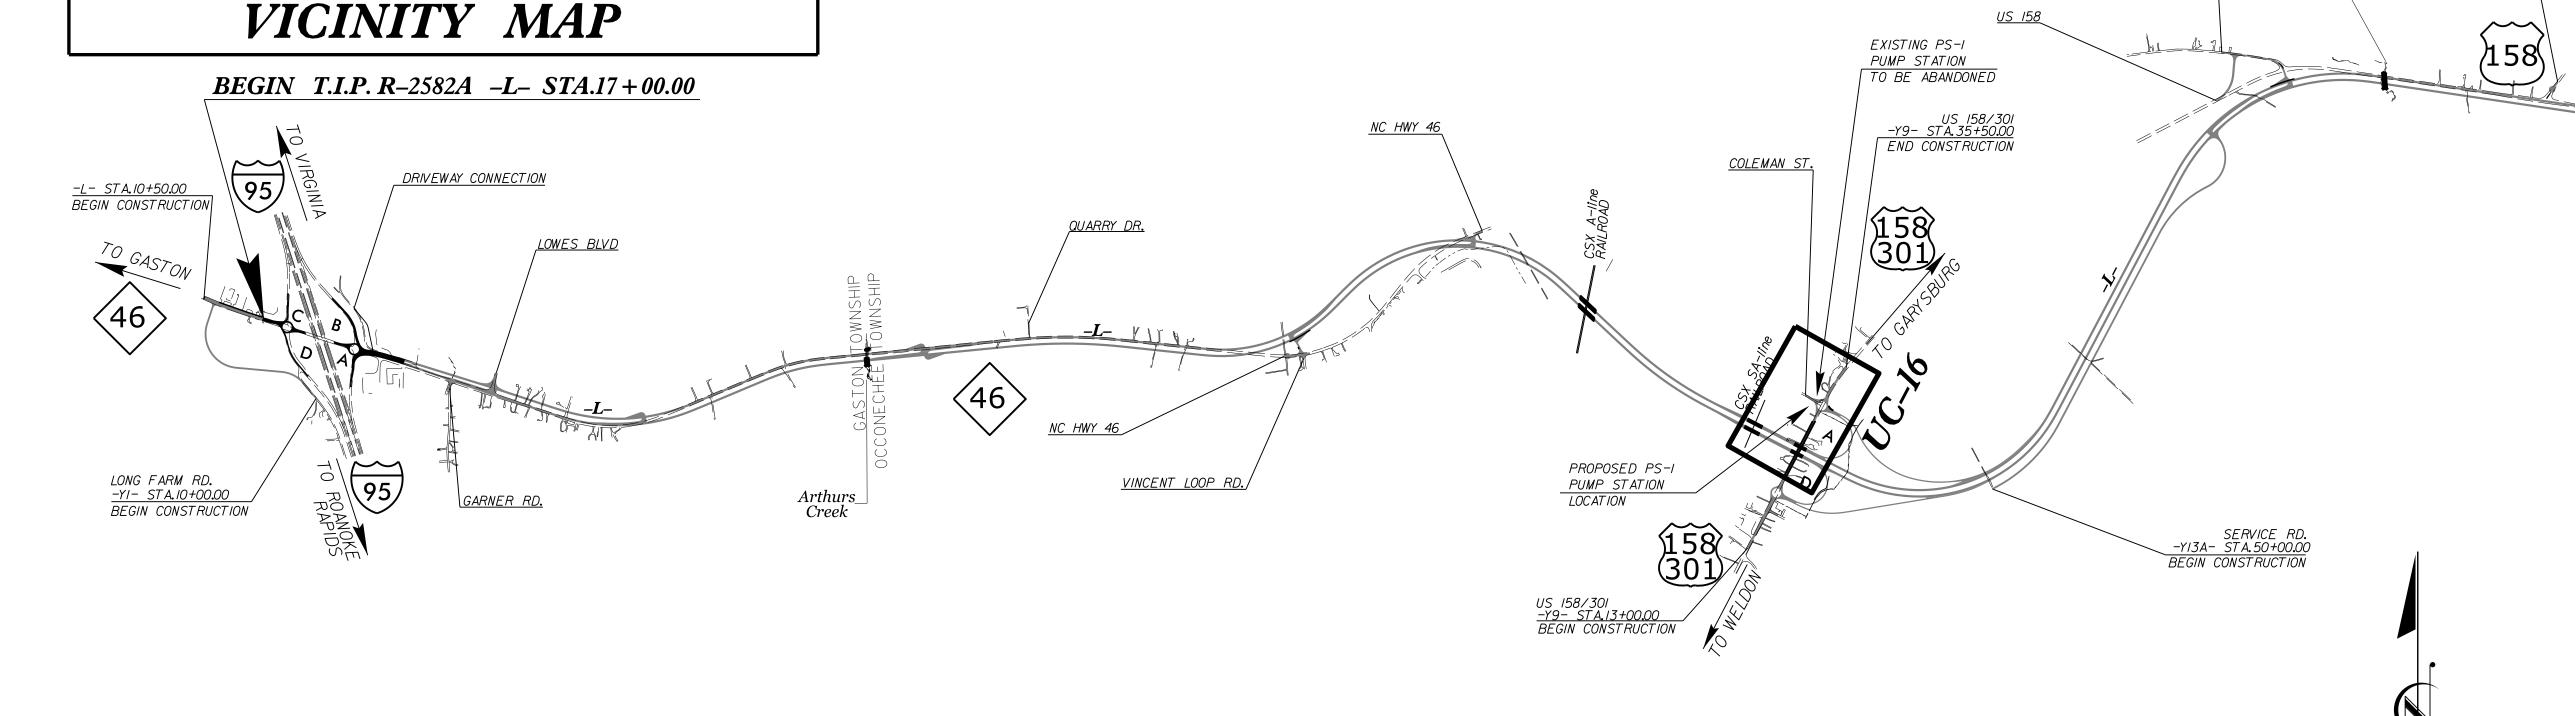

GRAPHIC SCALES

10 5 0 10 20

PLANS

DETAILS: AS NOTED

DAYS CROSSROADS

> INDEX OF SHEETS **DESCRIPTION: SHEET NO.:** TITLE SHEET *UC–48* SITE PLAN *UC-49* GRADING PLAN UC-50 UC-51 **DETAILS** *UC-52* **DETAILS** UC-53 **DETAILS** UC-54 ELECTRICAL TITLE SHEET UC-55 ELECTRICAL POWER RISER CONDUIT AND CABLE SCHEDULE *UC-56 UC-57* SERVICE CANOPY DETAILS

UTILITY OWNERS


(A) SANITARY SEWER – NORTHAMPTON COUNTY (B) WATER – NORTHAMPTON COUNTY (C) POWER – DOMINION ENERGY



KEVIN C. ZDEB, PE PROJECT ENGINEER

SAM FORSTER PROJECT DESIGNER

SAM FORSTER PROJECT DESIGNER
WEBB WHITE PROJECT UTILITY COORDINATOR

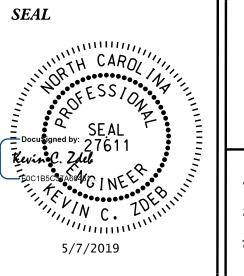




DIVISION OF HIGHWAYS UTILITIES UNIT 1020 BIRCH RIDGE DRIVE RALEIGH NC 27610 PHONE (919) 707–6690 FAX (919) 250–4151


NABIL HAMDAN


KIFAH KAMIL


DAYTON MARTIN

REGIONAL UTILITIES ENGINEER
SENIOR UTILITIES ENGINEER
REGIONAL UTILITY COORDINATOR

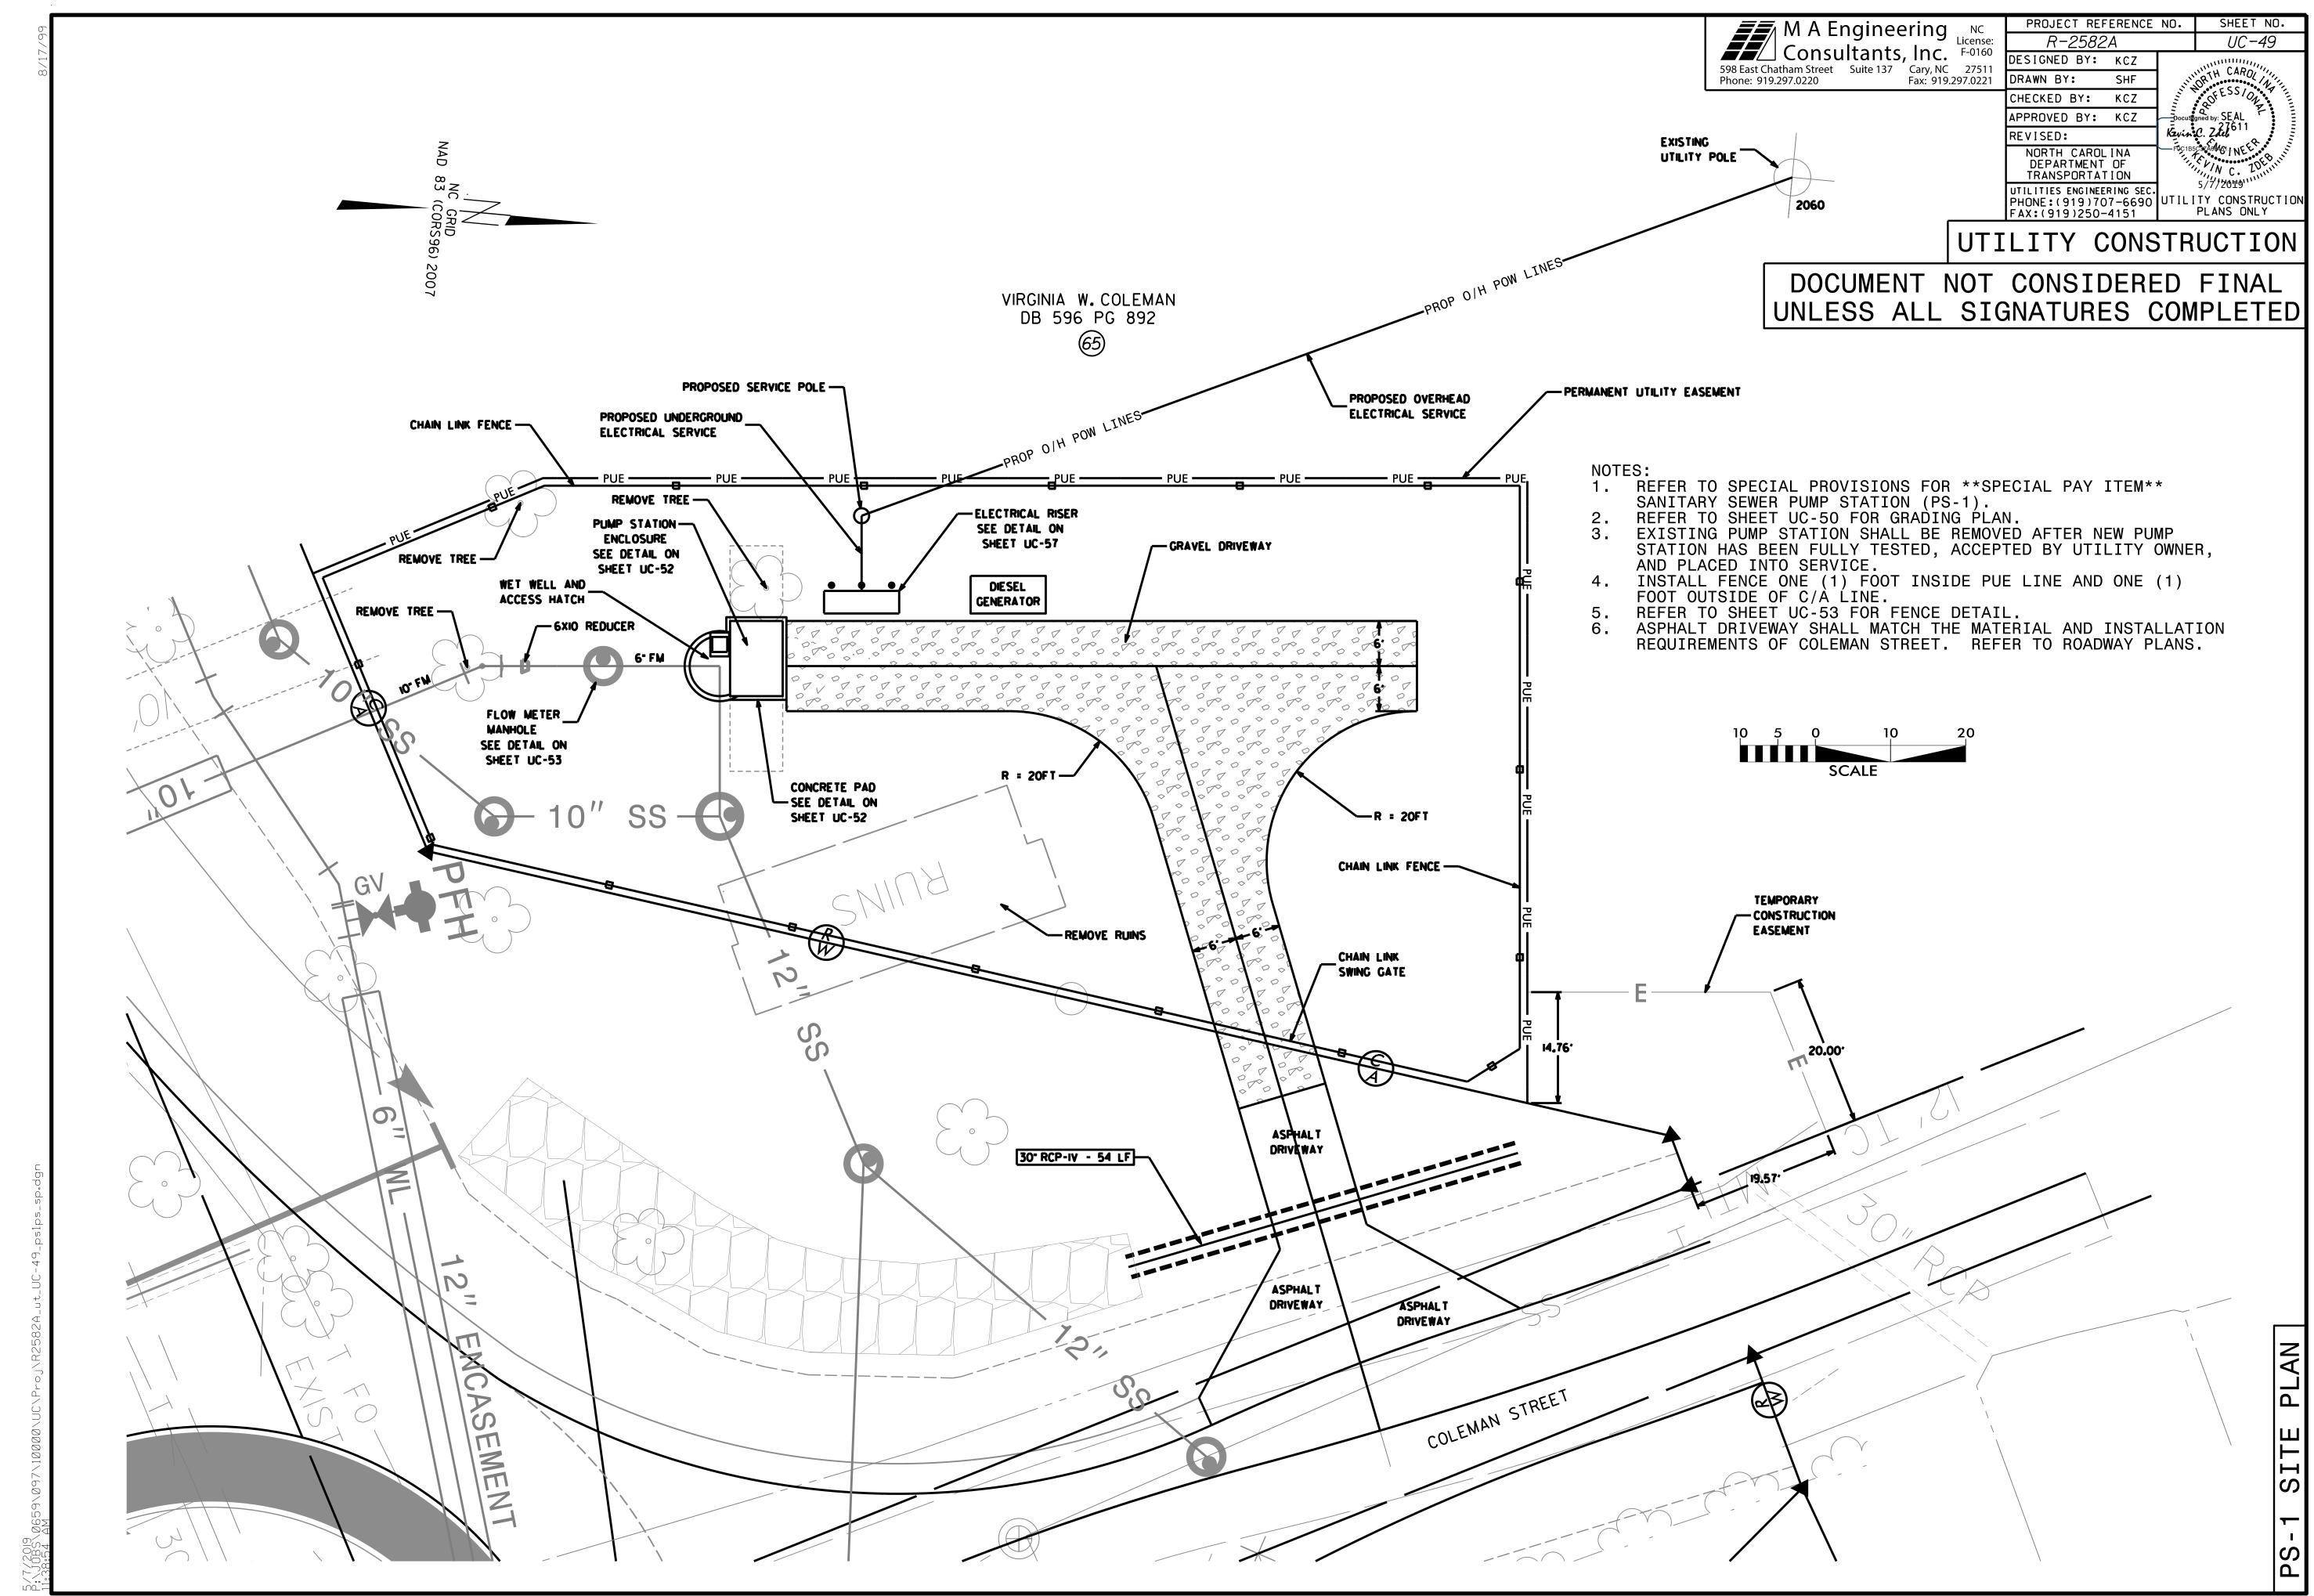

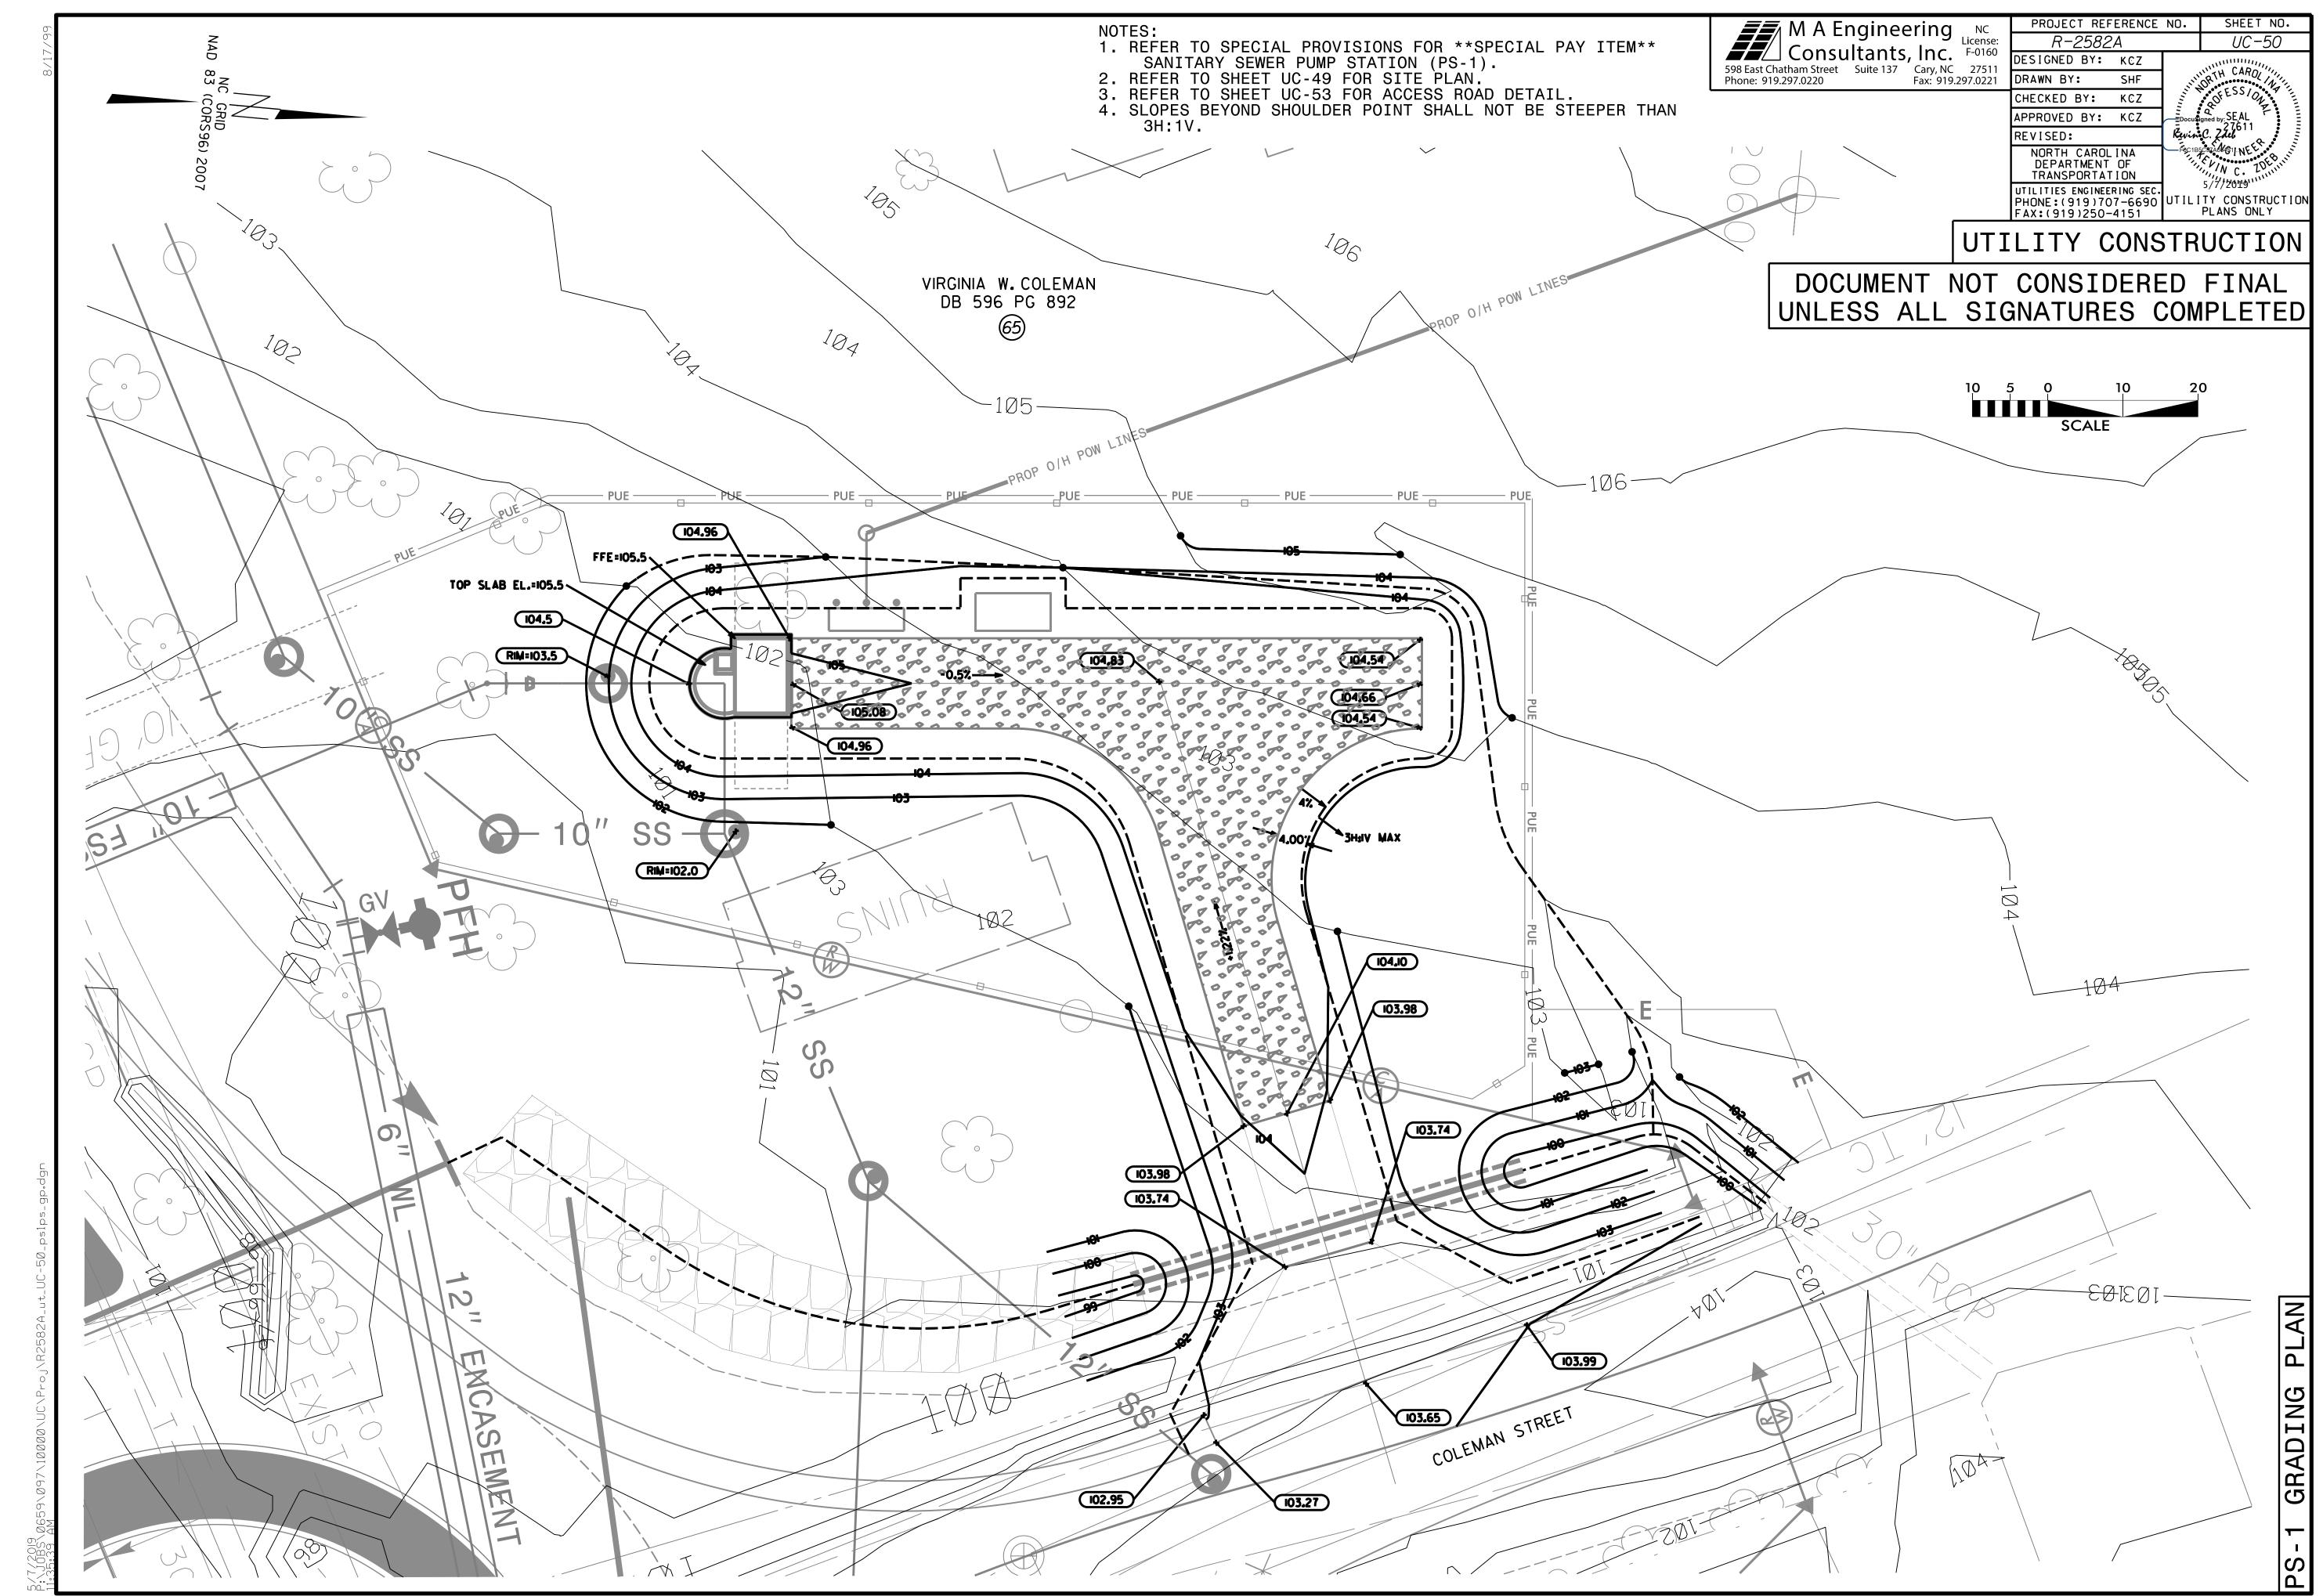

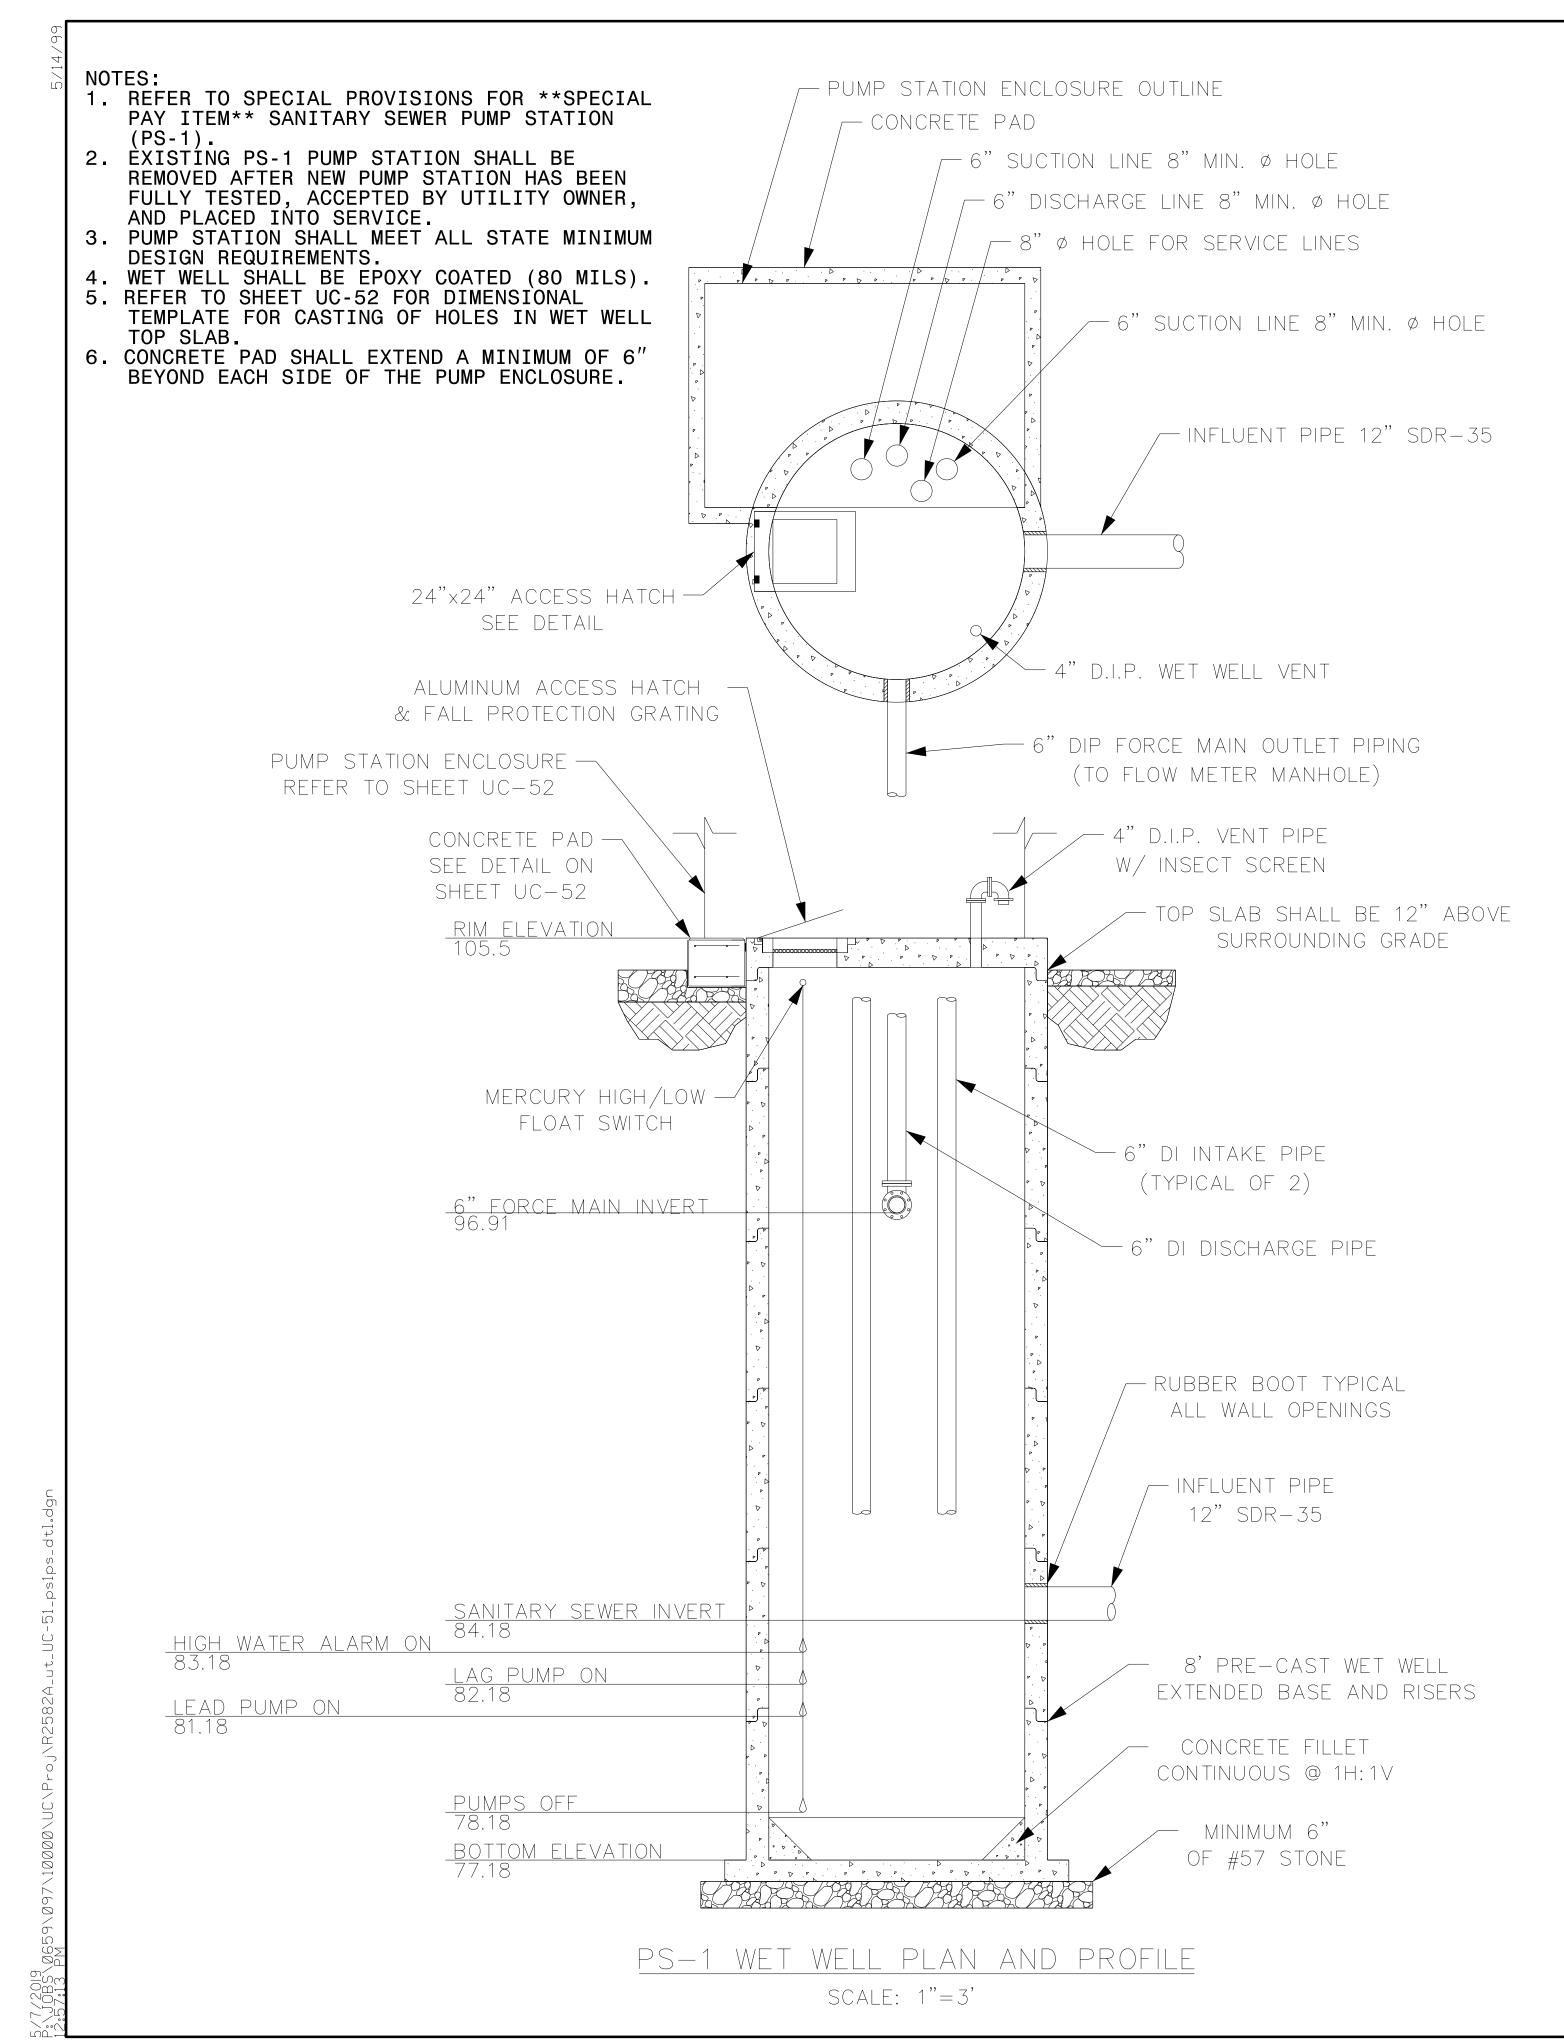

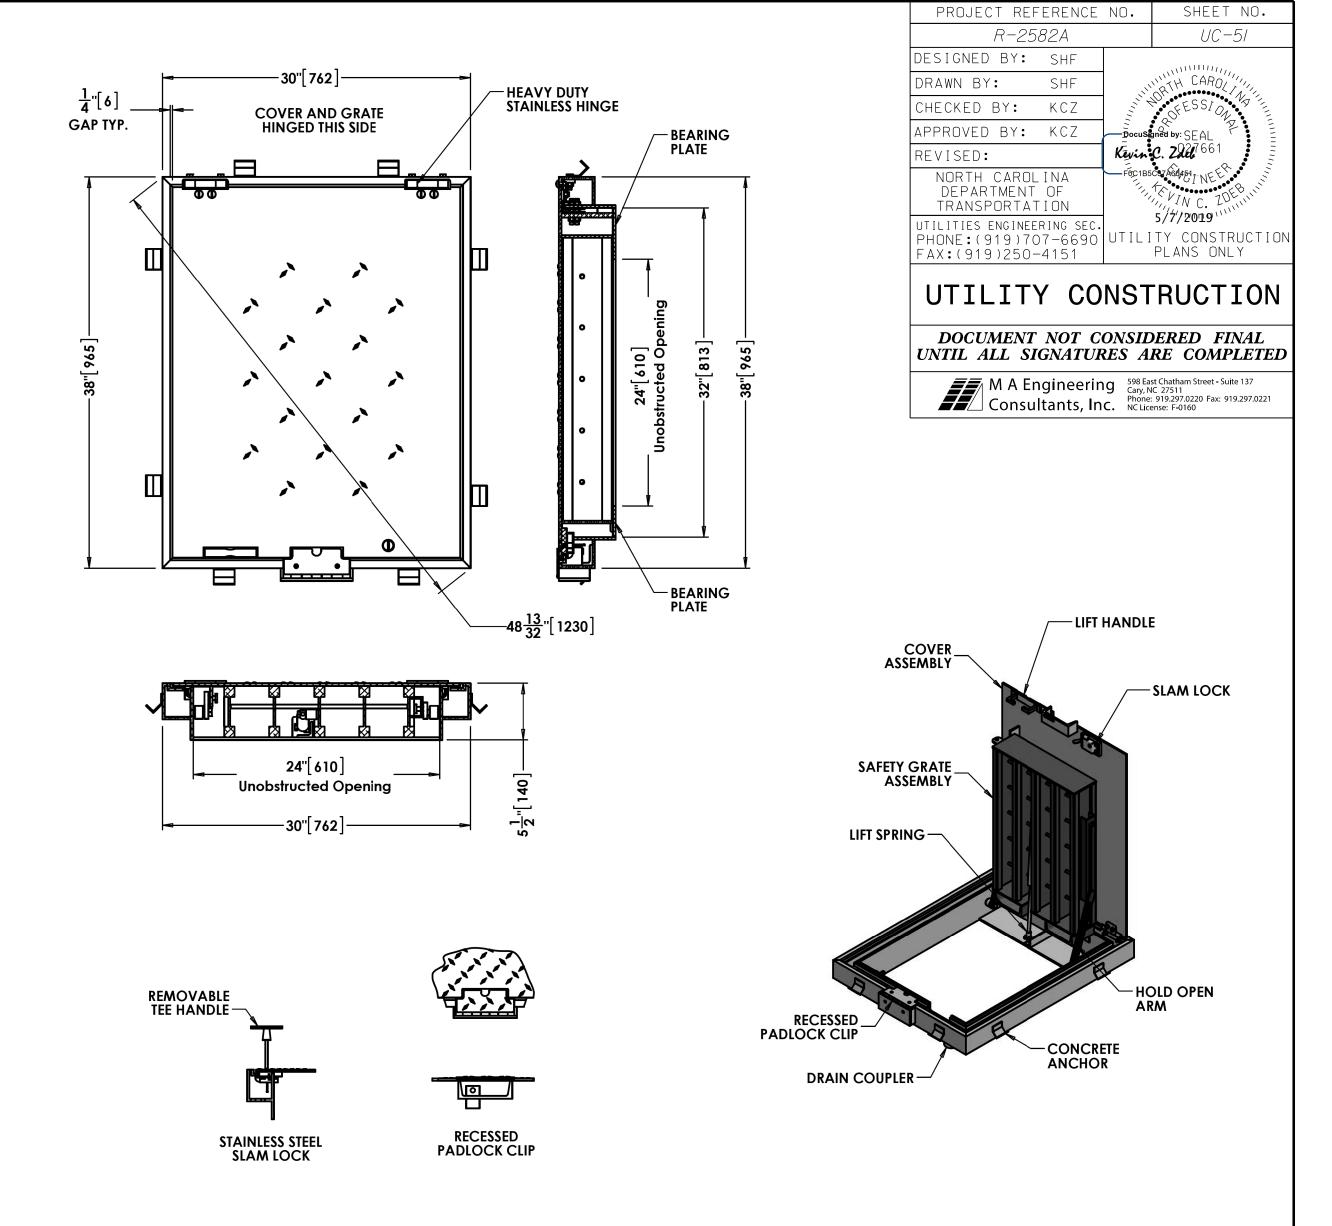

NOTES:

1. MATERIAL SHALL BE 6061-T6 ALUMINUM FOR BARS, ANGLES AND EXTRUSIONS, 1/4"
DIAMOND PLATE SHALL BE 5086 ALUMINUM.

2. UNIT DESIGNED HEAVY DUTY, FOR 16,000 LBS + 30% IMPACT H-20 WHEEL LOADS, OVER A 10" X 20" CONTACT AREA. FRAMES AND BEARING PLATE MUST BE CAST INTO AND SUPPORTED BY CONCRETE DESIGNED FOR H-20 WHEEL LOADS.

3. UNIT NOT SUITABLE FOR WHEEL LINE PLACEMENT.

4. UNIT SUPPLIED WITH A HEAVY DUTY PNEU-SPRING, FOR EASE OF OPERATION WHEN OPENING GRATE. GRATE SHALL BE COUNTERBALANCED, SO ONE PERSON CAN EASILY OPEN THE SAFETY GRATE.

5. FRAME SHALL BE OF EXTRUDED ALUMINUM. A DOVETAIL GROOVE SHALL BE EXTRUDED INTO THE SEAT OF THE FRAME FOR A 1/8" SILICONE GASKET.

6. EACH HATCH SHALL BE EQUIPPED WITH A STAINLESS STEEL HOLD OPEN ARM. DOOR SHALL LOCK OPEN IN THE 90 DEGREE POSITION. HOLD OPEN ARM SHALL BE FASTENED TO THE FRAME WITH A 1/2" GRADE 316 STAINLESS STEEL BOLT.
7. HINGES SHALL BE OF HEAVY DUTY DESIGN. MATERIAL SHALL BE GRADE 316 STAINLESS

7. HINGES SHALL BE OF HEAVY DUTY DESIGN. MATERIAL SHALL BE GRADE 316 STAINLESS STEEL. EACH HINGE SHALL HAVE A GRADE 316 STAINLESS STEEL, 3/8" DIAMETER HINGE PIN. HINGE SHALL BE FASTENED TO THE CHANNEL FRAME AND DIAMOND PLATE WITH GRADE 316 STAINLESS STEEL BOLTS AND NY-LOCK NUT.

8. ALUMINUM SHALL BE SUPPLIED WITH MILL FINISH. EXTERIOR OF FRAME WHICH COMES IN CONTACT WITH CONCRETE SHALL HAVE ONE COAT BLACK PRIMER.


9. EACH HATCH SHALL BE SUPPLIED WITH A STAINLESS STEEL SLAM LOCK, WITH THE KEY


9. EACH HATCH SHALL BE SUPPLIED WITH A STAINLESS STEEL SLAM LOCK, WITH THE KEY WAY PROTECTED BY A THREADED ALUMINUM PLUG. THE PLUG SHALL BE FLUSH WITH THE TOP OF THE 1/4" DIAMOND PLATE. THE SLAM LOCK SHALL BE FASTENED WITH GRADE 316 STAINLESS STEEL BOLTS AND WASHERS.

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11. EACH HATCH SHALL BE EQUIPPED WITH A STAINLESS STEEL LIFT HANDLE. LIFT HANDLES
SHALL BE FLUSH WITH TOP OF 1/4" DIAMOND PLATE.


12. EACH HATCH IS SUPPLIED WITH A 1-1/2" THREADED DRAIN COUPLER ON THE UNDERSIDE OF CHANNEL FRAME, FOR PIPE CONNECTION. (SPECIAL LOCATION).




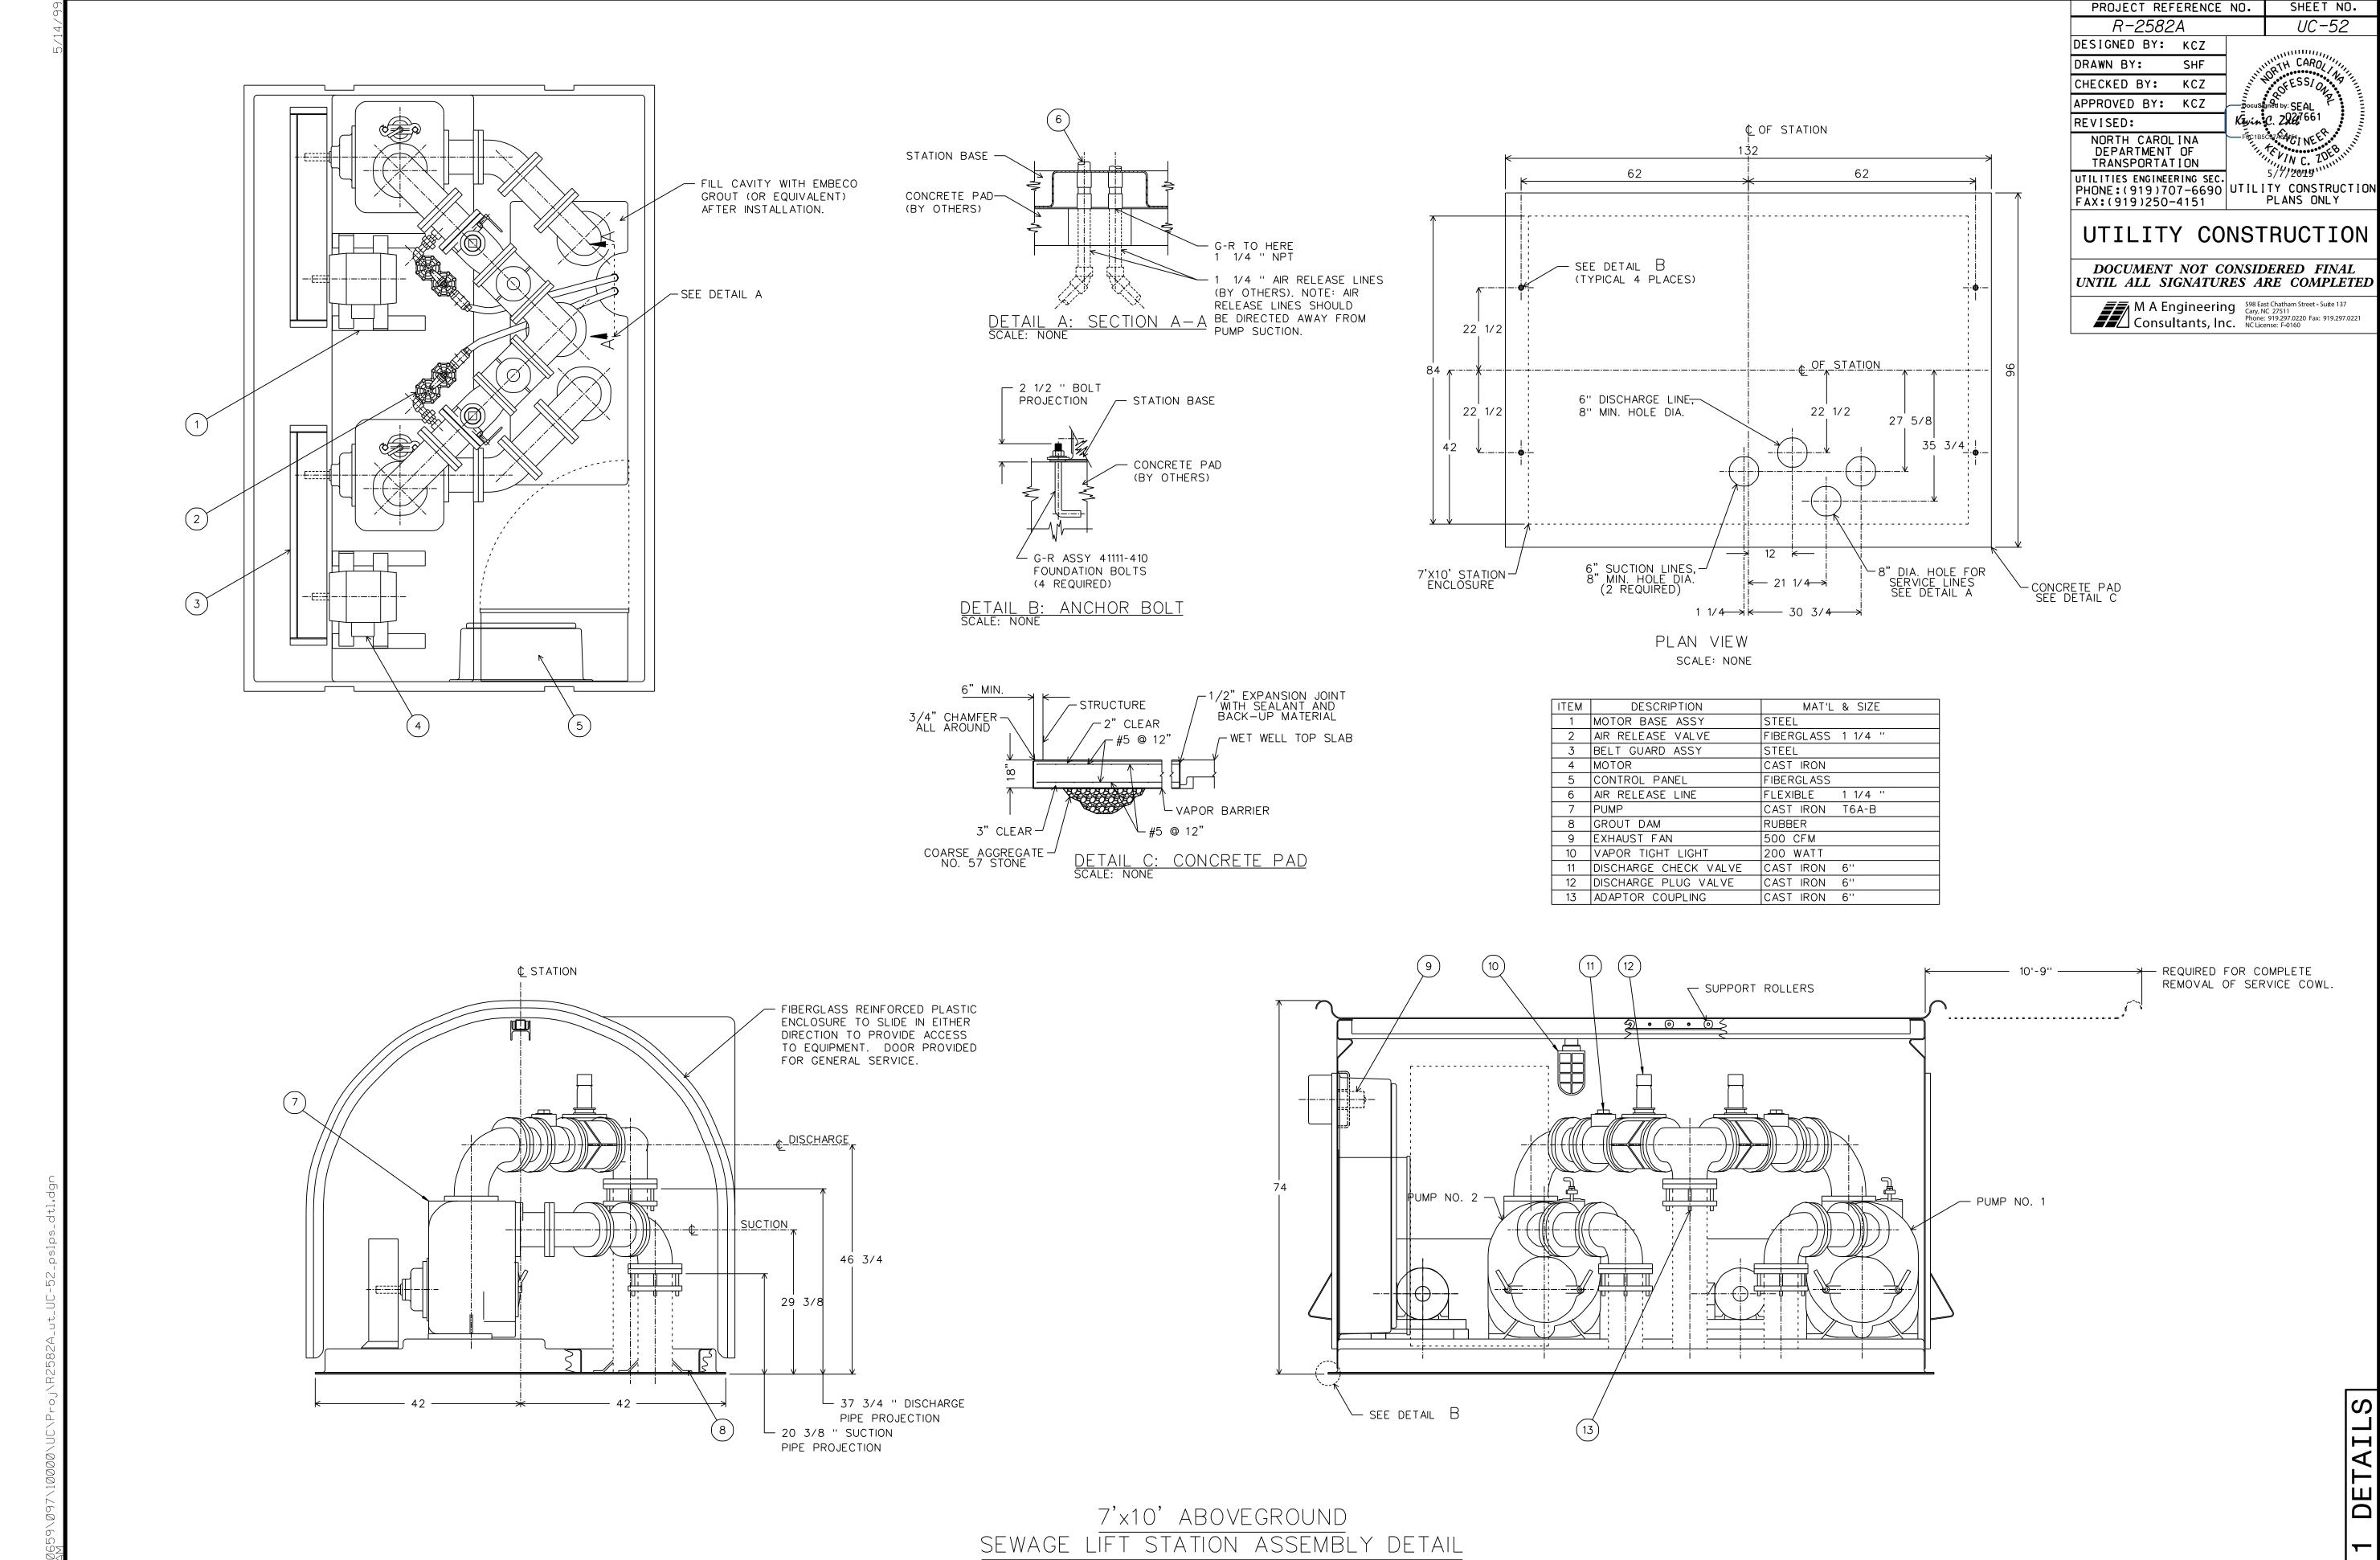

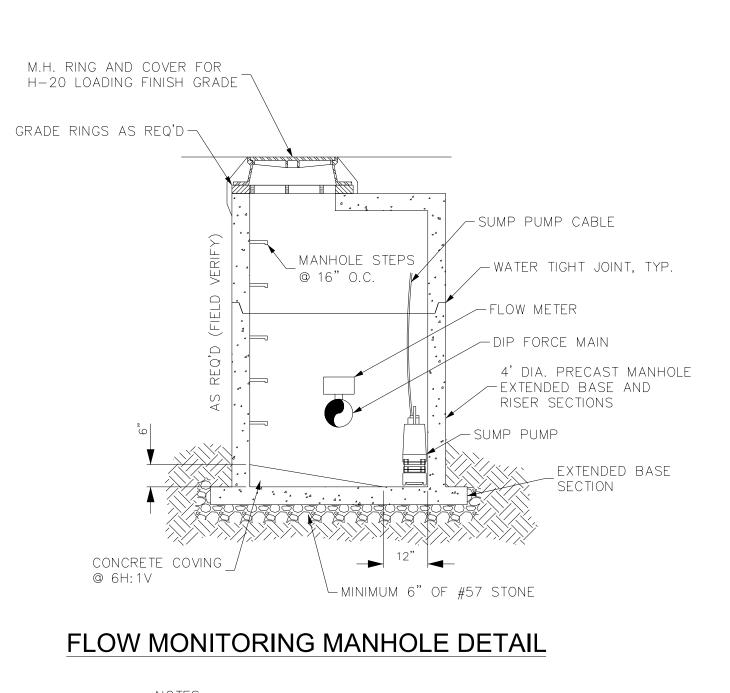


- 1. CONTRACTOR SHALL PROVIDE SEPARATE CONDUITS FOR FLOW METER WIRING AND
- SUMP PUMP. 2. CONDUITS SHALL SHALL BE RUN FROM FLOW METER MANHOLE TO PS-1
- ELECTRICAL RISER. 3. CONDUITS SHALL BE SIZED AS PER MANUFACTURER REQUIREMENTS.

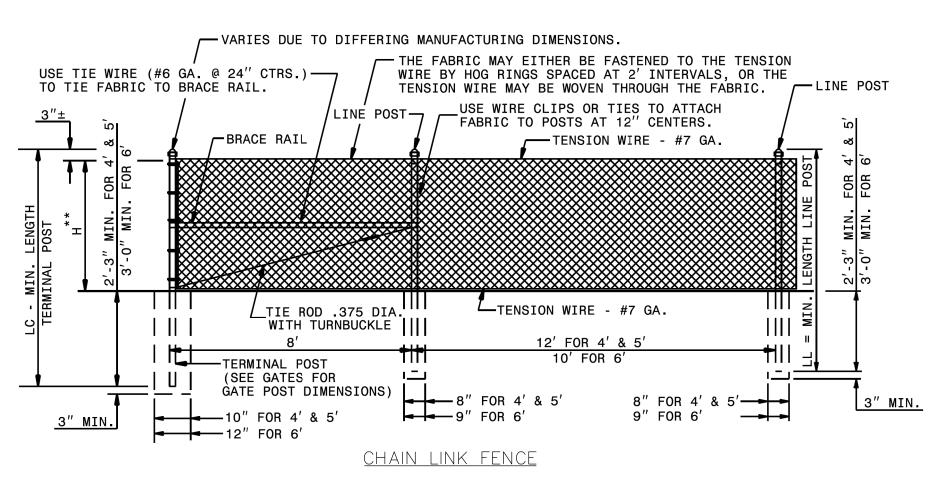

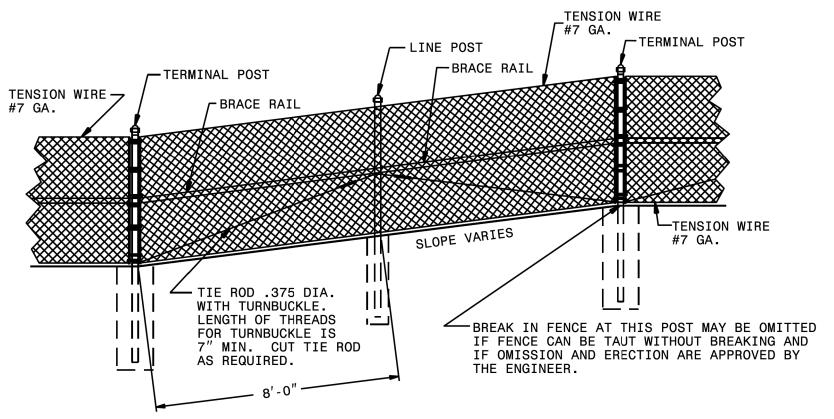



FENCE ON SHARP BREAK IN GRADE


1. SLOPES SHALL NOT BE STEEPER THAN 3H:1V BEYOND SHOULDER.

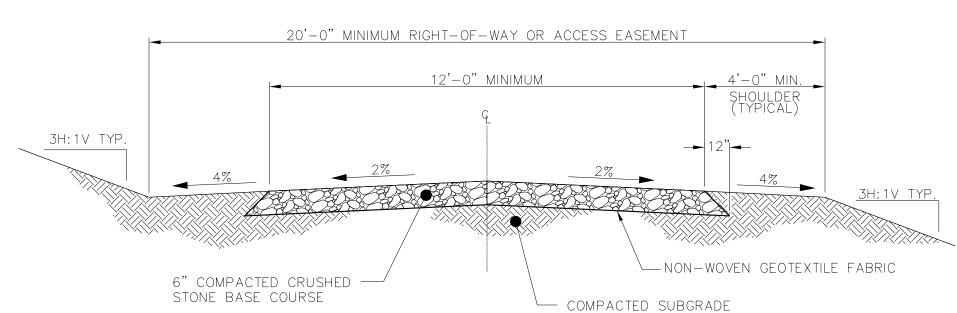

PS-1 PUMP STATION ACCESS ROAD DETAIL

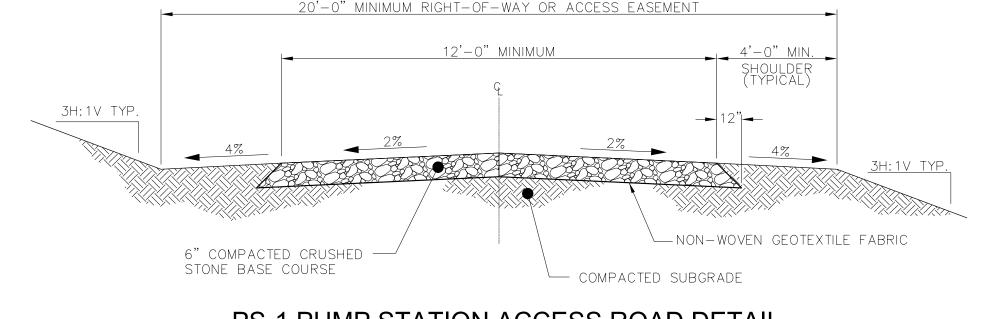

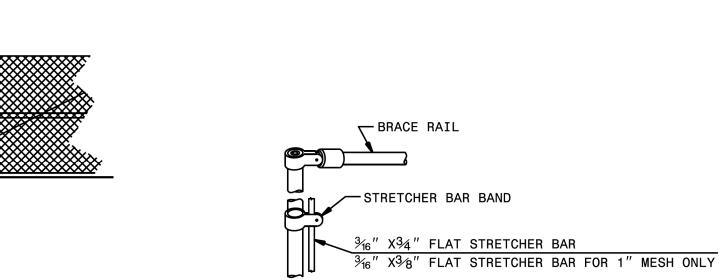

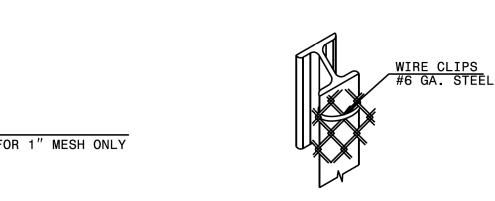

GATE OR TERMINAL POST WITH STRETCHER BAR ATTACHMENT

METHOD OF TYING FENCE TO 'H' POST

PROJECT REFERENCE NO.

SHF

UTILITY CONSTRUCTION

DOCUMENT NOT CONSIDERED FINAL

UNTIL ALL SIGNATURES ARE COMPLETED

M A Engineering
Consultants, Inc.

598 East Chatham Street - Suite 137
Cary, NC 27511
Phone: 919.297.0220 Fax: 919.297.0221
NC License: F-0160

R-2582A

DESIGNED BY: KCZ

CHECKED BY: KCZ

APPROVED BY: KCZ

NORTH CAROLINA DEPARTMENT OF TRANSPORTATION

UTILITIES ENGINEERING SEC

PHONE:(919)707-6690 FAX: (919)250-4151

DRAWN BY:


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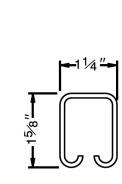
SHEET NO.


UC-53

UTILITY CONSTRUCTIO

PLANS ONLY



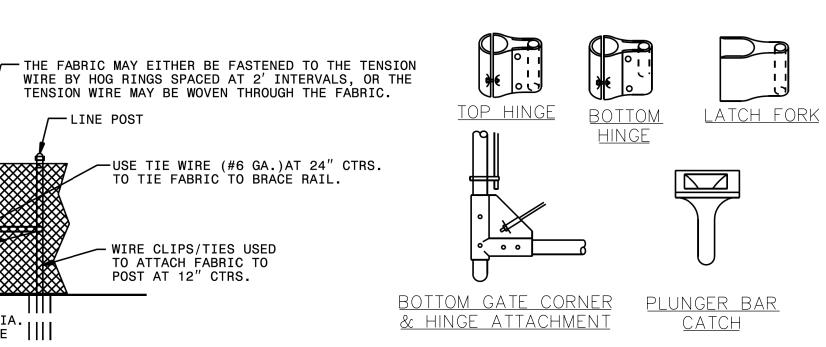

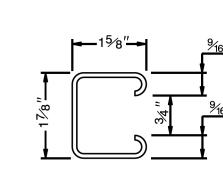

BRACE RAIL

LINE POST

FABRIC		#11 GAGE	
FRAME COMPONENTS		GALVANIZED STEE	L
SYSTEM	G1	G2	G3
LINE POST	2.375" O.D. STEEL PIPE	1.625" X 1.875" STEEL H	1.625" X 1.875" STEEL R.F.
TERMINAL POST (END, CORNER, BRACES)	2.875" O.D. STEEL PIPE	2.875" O.D. STEEL PIPE	2.875" O.D. STEEL PIPE
GATE POST UP THRU 6' LEAF	2.875" O.D. STEEL PIPE	2.875" O.D. STEEL PIPE	2.875" O.D. STEEL PIPE
GATE POST 7' THRU 12' LEAF	4.000" O.D. STEEL PIPE	4.000" O.D. STEEL PIPE	4.000" O.D. STEEL PIPE
BRACE RAIL	1.660" O.D. STEEL PIPE	1.660" O.D. STEEL PIPE	1.250" X 1.625" STEEL R.F. OR 1.660" O.D.

GALV. STEEL OR ALUMINUM COATED STEEL

FENCE ALONG RIGHT-OF-WAY BRACING ALLOWABLE COMPONENTS FOR FENCE SYSTEM

1. **H IS HEIGHT OF FENCE. REQUIRED HEIGHT IS 6 FEET.

∠WIRE FENCE

- 2. ROLL FORMED LINE POST MAY BE DRIVEN TO A MINIMUM OF 3'-0" IN LIEU OF CONCRETE ANCHOR, UNLESS OTHERWISE DIRECTED BY
- 3. CAPS ARE REQUIRED ON PIPE POST. CAPS ARE NOT REQUIRED ON "H" POST OR ROLL FORMED POST. INSTALL FENCE FABRIC ON THE SIDE FARTHEST FROM THE ROAD EXCEPT THAT ON HORIZONTAL CURVES GREATER THAN 3°, INSTALL THE FENCE TO PULL AGAINST LINE POST. CONSIDER ALL CHANGES IN DIRECTION OF FENCE LINE OF 30° OR MORE AS CORNERS.
- 4. MAXIMUM WIRE SPACING TO BE 6".

TERMINAL POST

- 5. MAXIMUM CLEARANCE BETWEEN LOWEST STRAND AND GROUND TO BE 6".
- 6. ERECT BRACE RAILS BETWEEN TERMINAL OR GATE POSTS AT INTERVALS NOT EXCEEDING 700' ON TANGENTS OR 350' ON SHORT RADIUS CURVES.
- 7. ERECT ADDITIONAL TERMINAL POSTS IF DIRECTED BY THE ENGINEER. 8. BRACE TERMINAL POSTS FROM BOTH SIDES OF POST.

R/W MARKER -

(A)12'

6' HIGH CHAIN LINK FENCE DETAILS

FENCE ALONG RIGHT-OF-WAY

LINE POST & TERMINAL POST SEQUENCE

— GATE POST

| || | <u>/</u>1.90"

12" FOR 4' & 5'

— LINE POST

—TENSION WIRE - #7 GA.

TENSION WIRE - #7 GA.

9" FOR 6' 10" FOR 4', & 5'

← WIRE FENCE

12" FOR 6'——

O.D. PIPE

- VARIES DUE TO DIFFERING MANUFACTURING DIMENSIONS

- 0.375" ROUND ROD

DOUBLE SWING GATE

TERMINAL POST

— BRACE RAIL

3" MIN.

LINE BRACE

2'-6" MIN. FOR 4' & 5 3'-0" MIN. FOR 6'

TERMINAL

_POST

✓ BRACE RAIL

— 1.90" O.D. PIPE

12" FOR 4' & 5'

LINE POST

-8" FOR 4' & 5'

9" FOR 6'

TENSION WIRE MAY BE WOVEN THROUGH THE FABRIC.

- WIRE CLIPS/TIES USED TO ATTACH FABRIC TO POST AT 12" CTRS.

←USE TIE WIRE (#6 GA.)AT 24" CTRS.

TO TIE FABRIC TO BRACE RAIL.

OPENING -

SYMBOLS

- 3/4" x 10' COPPER CLAD GROUND ROD; SEE DETAIL 2 SHEET E04 FOR CABLE CONNECTION DETAILS
- EXOTHERMIC WELD OR MECHANICAL CONNECTION; REFER TO APPROPRIATE DETAIL CONNECTION
- EQUIPMENT CONNECTION;
 COORDINATE WITH SUPPLIER
 PRIOR TO ROUGH-IN
 GFI RECEPTACLE;
- GFI RECEPTACLE;

 WEATHER PROOF COVER

 & BOX
 CONDUIT IDENTIFIER.

 C100 REFER TO CONDUIT &

CABLE SCHEDULE.

ELECTRICAL DISCONNECT;

NUMBER INDICATES TYPE; REFER

TO DISCONNECT SCHEDULE

SINGLE POLE SWITCH; COORDINATE LOCATION

WITH DOOR SWING & MILLWORK; MOUNTING
HEIGHT PER NC STATE BLDG CODE VOL 1-C

UNSWITCHED CIRCUIT
 SWITCHED CIRCUIT

	DRAWING SCHEDU			ત બ ન		
		ISSUE	OWNER'S COMMENTS	DOT REVIEW		
DRAWING NUMBER	DRAWING TITLE		02/22/2019	05/06/2019		
UC-54	ELECTRICAL COVER SHEET PS-1		•	•		
UC-55	ELECTRICAL POWER RISER PS-1		•	•		
UC-56	CONDUIT AND CABLE SCHEDULE PS-1		•			
UC-57	DETAILS PS-1		•	•		

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PROJECT REFERENCE NO. SHEET NO. R-2582A UC-54 ESIGNED BY: REF DRAWN BY: REF CHECKED BY: REF APPROVED BY: REF Ruse Finan31 REVISED: NORTH CAROLINA DEPARTMENT OF TRANSPORTATION UTILITIES ENGINEERING SEC. PHONE: (919)707-6690 UTILITY CONSTRUCTION PLANS ONLY FAX:(919)250-4151

UTILITY CONSTRUCTION

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ENERGY CODE INFORMATION

Electrical System and Equipment

Method of Compliance: Prescriptive

Lighting Schedule

Lamp type required in fixture — See Fixture Schedule Number of lamps in fixture — See Fixture Schedule Ballast type used in fixture — See Fixture Schedule Number of ballasts in fixture — See Fixture Schedule

Total wattage per fixture — See Fixture Schedule Total interior wattage specified vs. allowed — N/A

Total exterior wattage specified vs. allowed — 78.6 lumens/watt specified vs. 45 lumens/watt allowed

Equipment schedules with motors (not used for mechanical systems)

Motor horsepower — N/A
Number of phases — N/A
Minimum efficiency — N/A
Motor type — N/A
of poles — N/A


Designer Statement:

To the best of my knowledge and belief, the design of this building complies with the electrical system and equipment requirements of North Carolina International Energy code

Signed: _____ Name: REESE E. FINN Title: Engineer

		LIGH	T FIXTUF	RE SCH	HEDUI	LE
ID	DESCRIPTION	LAMP/ QTY	BALLAST/ QTY	VOLTS	WATTS	NOTES
A	LITHONIA EIS 2 54T5HO	T5H0 54W 2	GEB 1	120	108	ENCLOSED & GASKETED FLOURESCENT STRIP. WET LABEL. SURFACE MOUNTED. CONTRACTOR TO FURNISH & INSTALL.

MISC. DWG. SYMBOLS

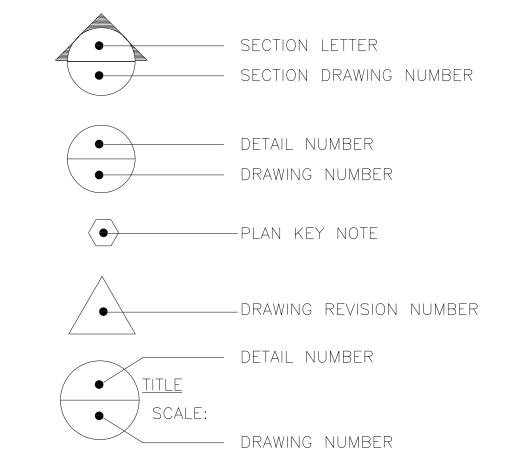

NOTE TO REVIEWER

NOTE TO REVIEWER

THIS APPLICATION IS TO PROVIDE UTILITY POWER, EMERGENCY GENERATOR BACK-UP, AND CONTROL WIRING FOR A RELOCATED PUMPING STATION.

UTILITY CONSTRUCTION

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Solution of the property of

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PNL PS

125 A

230

1 ELECTRICAL POWER RISER UC-55 SCALE: N.T.S.

— NEW O'HD TRANSFORMER BANK

UTILITY LATERALS —

APPROVED MECHANICAL LUG -

3/4" DIA. × 10' LG. COPPERCLAD GROUND ROD

BATCH PLANT FNDN ----

GENERAL NOTE:

#1/0 COPPER —

GRADE V

THE CONDUIT ROUTING IS DIAGRAMMATIC. REFER TO CONDUIT & CABLE SCHEDULE FOR SIZE & CABLE CONTENT. THE EXACT ROUTING AND COORDINATION WITH SITE CONDITIONS IS THE CONTRACTORS RESPONSIBILITY.

Keyed Notes:

- APPROVED

 MECHANICAL

 GROUNDING LUG.
- 40 KW DIESEL GENERATOR WITH BASE MOUNTED FUEL TANK, WEATHER/NOISE ENCLOSURE. MAIN BREAKER. SIX WINDINGS. 240 VAC 30.
- SUB-PANEL SUPPLIED WITH AND LOCATED IN SEWAGE LIFT STATION ENCLOSURE. COORDINATE WITH EQUIPMENT SUPPLIER.
- UTILITY METER. COORDINATE LOCATION AND TYPE WITH UTILITY.
- 3P NEMA 3R DISCONNECT

 WITH SOLID NEUTRAL AND GROUND. SE RATED.
- ASCO 300 SERIES (260-400)
 AMPERE) "J" FRAME AUTOMATIC TRANSFER SWITCH.

	VOLTAGE: 230 AMPS: 200						P	ANEL MDF	>	MAIN BREAKER: M.LO. PHASE: 3 WIRE: 4							
	AIC: 12,158						MOUNTING: SURFACE										
							PH	ASE LOAD	os								
αкт	DESCRIPTION	С	W	Р	СВ		Α	В	С	VA	СВ	Р	W	С	DESCRIPTION	CK	
1	PANELPS	1-1/2	1/0	3	150	13034	13214			180	20	1	12	1/2	RECEPTACLE	2	
3				3	150	12154		12154							HI-LEG		
5				3	150	13234			15154	1920	20	1	12		⊔GHTS	- 6	
	RECEPTACLE	1/2	12	1	20	180	480			300	15	1	14	1/2	FLOW METER	8	
9	HI-LEG							0							HI-LEG	1	
11									0							1.	
13							0									1	
15								0								10	
17									0							1	
19							0									2	
21								0								2	
23									0							2	
25							0									2	
27								0								2	
29								0								3	
					VA	√PHASE:	13694	12154	15154					N	IECLOAD: 45666		
						OTAL VA:		41003							AMPS: 115		
					TOT	ALAMPS:		103									
NOT	ES:			N	IECLOAD	/ PHASE:	15089	13549	17029								
1. PF	OVIDE BOLT-ON BREAKE	RS															
2. S C	UARE D NQOD																

	VOLTAGE: 230 AMPS: 125 AIC: 10 K		F	PANELPS							MAIN BREAKER: M.L.O. PHASE: 3 WIRE: 4 MOUNTING: SURFACE					
		Т					PH	ASE LOAD	s							
CKT	DESCRIPTION	С	w	P	СВ		Α	В	С	VA	СВ	Р	W	С	DESCRIPTION	СКТ
1	15 hP PUMP	1	6	3	80	5577	11154			5577	20	3	6	1	15 hP PUMP	2
3				3	80	5577		11154		5577		3				4
5				3	80	5577			11154	5577		3				6
	INTERIOR LIGHT	1/2	12	1	20	200	380			180	20	1	12	1/2	RECEPTACLE	8
9	HI-LEG							0							HI-LEG	10
11	CONTROLS	1/2	14	1	15	300			480	180	20	1	12	1/2	RECEPTACLE	12
13	SPACE HEATER	1/2	12	2	20	250	1250			1000	15	3	14	1/2	POWER TRANSFORMER	14
15	HI-LEG							1000		1000	15					16
17	AIR PUMP	1/2	14	1	15	250			1250	1000	15					18
19	AIR PUMP	1/2	14	1	15	250	250									20
21	HI-LEG							0							HI-LEG	22
23	EXHAUST FAN	1/2	14	1	15	350			350							24
25							0									26
27	HI-LEG							0							HI-LEG	28
29									0							30
31							0									32
33	HI-LEG							0							HI-LEG	34
35									0							36
37							0									38
39	HI-LEG							0							HI-LEG	40
41								0								42
					VA	/ PHASE:	13034	12154	13234		I	1		N	IEC LOAD: 44000	
					T	OTAL VA:		38423							AMPS: 110	
					TOT	ALAMPS:		96								
ЮТ	ES:			N	EC LOAD	/ PHASE:	14429	13549	16023							
. P.A	NEL PROVIDED BY ENCLO	SURE SI	JPPLIE	ER.				'								

3/17/99



PROJECT REFERENCE	NO.	SHEET NO.
R-2582A		UC-56
DESIGNED BY: REF		
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CHECKED BY: REF		MILLESS 10 THAT
APPROVED BY: REF	Docusi	gned by EAL
REVISED:	Res	Final /
NORTH CAROLINA DEPARTMENT OF TRANSPORTATION	E /6 /20	SE E F
UTILITIES ENGINEERING SEC. PHONE: (919)707-6690 FAX: (919)250-4151	5/6/20 UTILI	TY CONSTRUCTION PLANS ONLY

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CONDUIT AND CABLE SCHEDULE				
CONDUIT I.D.	CONDUIT SIZE	CABLE/ WIRE	FROM	ТО
C001	2"	3 #3/0 THHN COPPER	METER BASE	DISC A
C002	2"	3 #3/0 THHN COPPER, #6 G	DISC A	ATS
C003	2"	3 #3/0 THHN COPPER, #6 G	ATS	DISC G
C004	2"	3 #3/0 THHN COPPER, #6 G	ATS	MDP
C005	1-1/4"	3 #1 THHN COPPER, #8 G	MDP	PNL PS



<u>GENERAL NOTES:</u>

- ALL CONDUIT IS RIGID ALUMINUM

 1 UNLESS OTHERWISE NOTED ON THE PLANS
- CONTRACTOR IS RESPONSIBLE FOR ACTUAL

 2 QUANTITIES BASED ON TAKE OFF & FIELD CONDITIONS.

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<u>Keyed Notes:</u>

- 60×60×12 NEMA 3R CONTROL

 (1) CABINET, PROVIDE BACK PANEL
 AND LOCKING HANDLE.
- MOUNT ATS, MDP, FLOW METER CONTROL UNIT, AND MISC. CONTROL UNITS. SIZE IS NOMINAL. CONFIRM SPACE REQUIREMENTS WITH EQUIPMENT SUPPLIERS.
- GFI RECEPTACLE

 WITH IN-USE
 COVER.
- SP SWITCH WITH WP COVER, CONTROLS CANOPY LIGHT.
- 3P NEMA 3R DISCONNECT

 SVITH SOLID NEUTRAL AND GROUND. SE RATED.
- WARMA FLASHING RED LED WARNING LIGHT. COORDINATE WITH CONTRLS VENDOR.

